


PROPOSED TOWNHOUSE DEVELOPMENT - CIVIL DESIGN LOT 1257-1259 RAPID CREEK ROAD, RAPID CREEK, NORTHERN TERRITORY

DRAWING INDEX & LOCALITY MAP

REFEREN	ICE TITLE	REV
CIVIL		<u> </u>
C01	DRAWING INDEX	A
C02	GENERAL NOTES (1 OF 2)	A
C03	GENERAL NOTES (1 OF 2)	A
C04	LAYOUT PLAN	A
C05	EARTHWORKS (1 OF 2)	A
C06	EARTHWORKS (2 OF 2)	A
CIVIL: AC	CESS ROADS	
C07	ACCESS ROAD - SECTIONS	A
CIVIL: ST	ORMWATER DRAIN	
C08	LAYOUT PLAN - STORMWATER DRAINAGE	A
C09	DRAINAGE - LONGITUDINAL SECTION	А
CIVIL: W	ATER RETICULATION	
C10	LAYOUT PLAN - WATER RETICULATION	A
CIVIL: SE	WER	
C11	LAYOUT PLAN - SEWER	A
C12	SEWER - LONGITUDINAL SECTION	А
CIVIL: DE	TAILS	
C13	CIVIL DETAILS - PIPE BACKFILL	A
C14	CIVIL DETAILS - PAVEMENT DETAIL	A
C15	CIVIL DETAILS - JUNCTION PIT	A

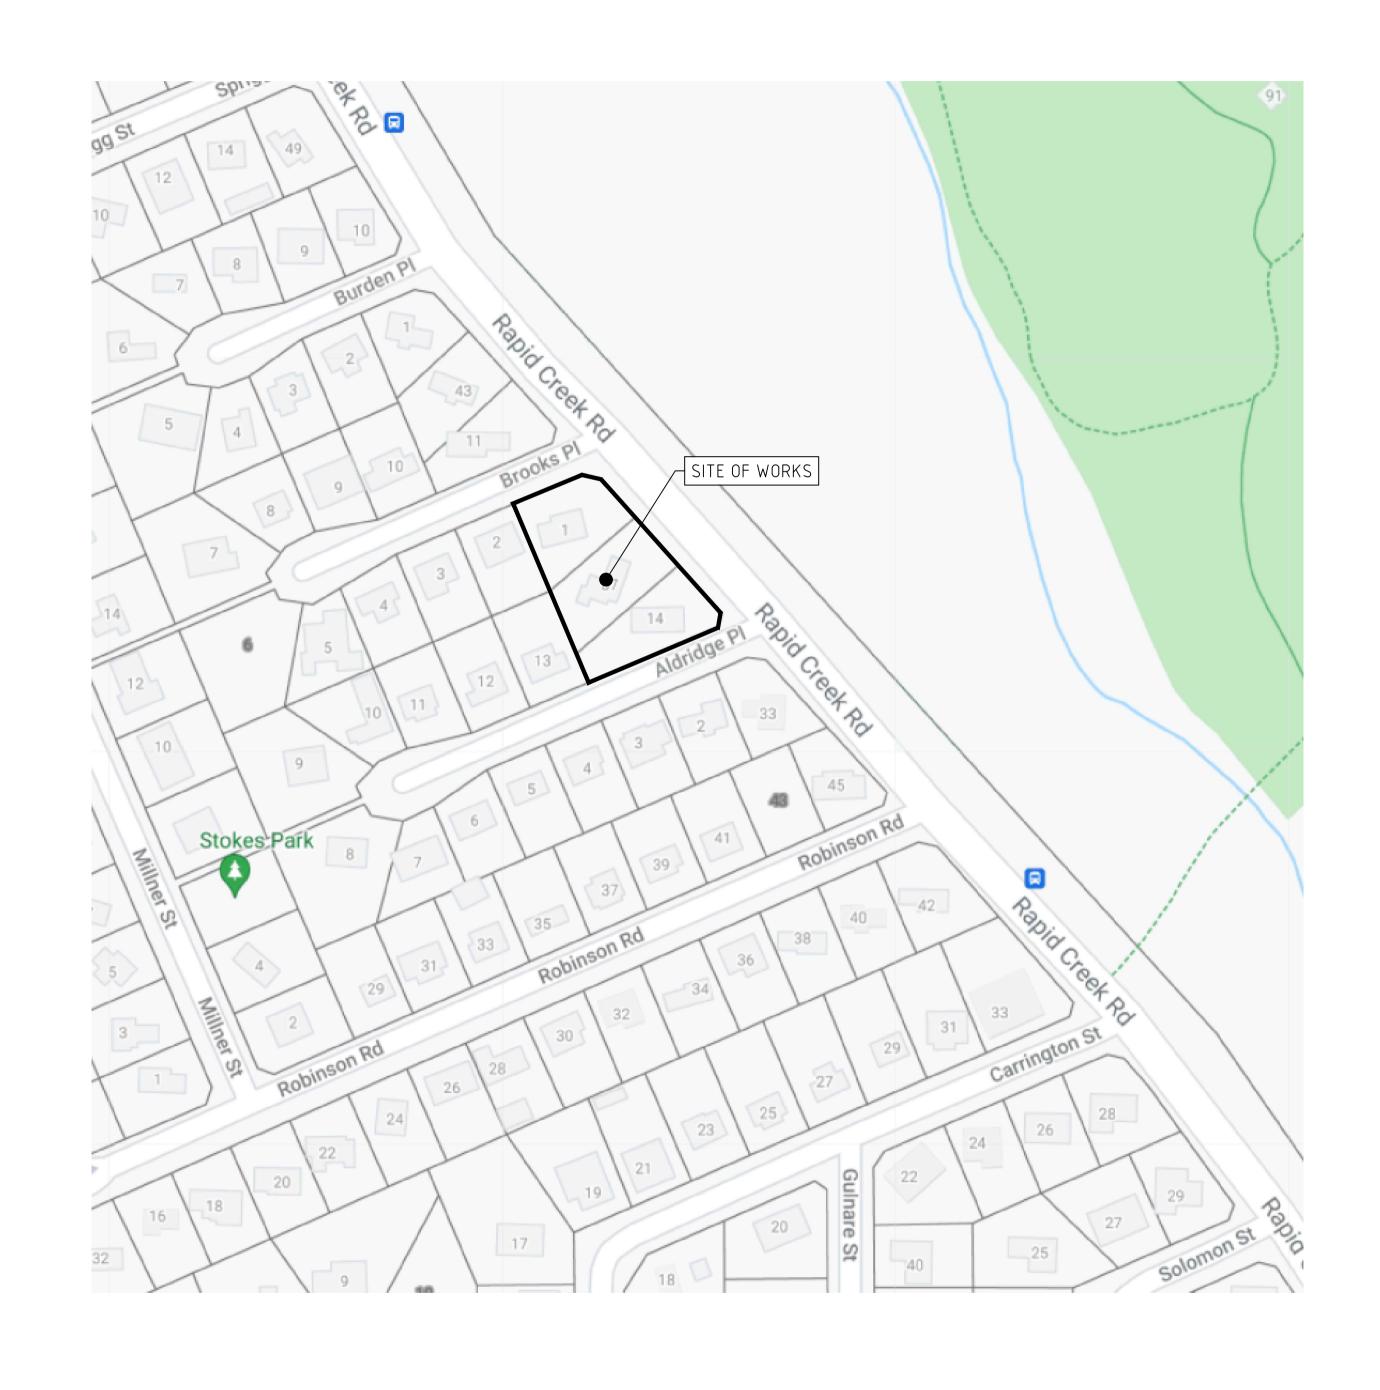

-	-	-	-	-				
_	-	-	-	-				
_	-	-	-	-				
_	-	-	-	-				Consulting En
А	08/04/2021	ISSUED FOR REVIEW	J.L.	J.G.				ADDRESS: SUITE 704, 1 PRINCES STREET, KEW, VIC, 31
REV	DATE	DESCRIPTION	DRAWN	APP'D	No	DRAWING NUMBER	REFERENCE DRAWING TITLE	PHONE: 03 9853 1218

G&P Consulting Engineers	C EI O P T R T D EI S LI
ADDRESS: SUITE 704, 1 PRINCESS	F.

COPYRIGHT OF THIS DRAWING IS VESTED IN G&P CONSULTING ENGINEERS AND THIS DRAWING/FILE IS NOT TO BE REPRODUCED OR COPIED IN WHOLE OR IN PART, IN ANY FORM, WITHOUT THE PRIOR WRITTEN APPROVAL OF G&P CONSULTING ENGINEERS. THE RECIPIENT IS RESPONSIBLE FOR ENSURING THAT THEY REVIEW THE STATUS OF THIS DRAWING, AND ARE IN RECEIPT OF THE CURRENT REVISION PRIOR TO USE. EXCEPT WHERE FIGURED DIMENSIONS HAVE BEEN PROVIDED, G&P CONSULTING ENGINEERS IS NOT RESPONSIBLE FOR DIMENSIONING AND SETTING OUT. THIS DRAWING HAS NOT BEEN PRODUCED TO A LEVEL OF DIMENSIONAL ACCURACY SUITABLE FOR FABRICATION. THE CONTRACTOR IS RESPONSIBLE FOR PRODUCTION OF FABRICATION / SHOP DRAWINGS WHERE THESE ARE REQUIRED. THIS DRAWING HAS BEEN REPRODUCED FOR THE NAMED CLIENT FOR USE ON THIS PROJECT ONLY AND IS NOT TO BE USED FOR ANY OTHER PURPOSE.
ART OTHER TORK OSE.

NG	CLIENT	
uced The S.	LOUW GROUP	
PT OF JRED	PROJECT	I
A TION.	PROPOSED TOWNHOUSE DEVELOPMENT - CIVIL DESIGN	
RED.	PROJECT ADDRESS	Ì
IENT OR	LOT 1257-1259 RAPID CREEK ROAD, RAPID CREEK, NT	

		RAWING TITLE	D	
	X	N & DRAWING INDEX	ALITY PLA	LOC
_	REVISION	DRAWING REFERENCE	DRAWING CHECK	DRAWN
		$C \cap A$	J.G.	J.L.
			DESIGN CHECK	DESIGNED
	Λ	(() 1	DESIGN CHECK	
	A		J.G.	J.L.

NOTES

1. <u>GENERAL</u>

- ALL WORKS TO BE CARRIED OUT IN ACCORDANCE WITH THE CURRENT STANDARD DRAWINGS AND SPECIFICATIONS OF DARWIN CITY COUNCIL.
- 1.2. DO NOT SCALE DRAWINGS USE ONLY DIMENSIONS PROVIDED ON PLANS.
- ALL DIMENSIONS ARE IN METRES (m) UNLESS OTHERWISE STATED.
- ALL LEVELS ARE TO AUSTRALIAN HEIGHT DATUM (A.H.D.) IN METRES (m) UNLESS OTHERWISE STATED.
- EXISTING DRAINAGE AND UNDERGROUND SERVICES ARE TO BE LOCATED PRIOR TO THE COMMENCEMENT OF WORKS AND RELEVANT AUTHORITIES NOTIFIED. FOR SERVICE INFORMATION CONTACT "DIAL BEFORE YOU DIG". ANY DAMAGE AND SUBSEQUENT REPAIRS WILL BE THE RESPONSIBILITY OF THE CONTRACTOR.
- 1.6. THE CONTRACTOR IS TO ARRANGE FOR THE RELOCATION OF UNDERGROUND SERVICES IF REQUIRED, PRIOR TO THE COMMENCEMENT OF WORKS.
- 1.7. THE CONTRACTOR SHALL BE RESPONSIBLE FOR ADVISING THE WORKS SUPERINTENDENT AND THE C.F.A. OPERATIONS CENTRE OF THE RELOCATION OR ALTERATION OF ANY FIRE HYDRANTS WITHIN ONE WORKING DAY.
- 1.8. WHERE THE MANAGEMENT OF TRAFFIC DURING CONSTRUCTION REQUIRES REDUCED SPEED LIMITS, THE CONTRACTOR SHALL BE RESPONSIBLE FOR SUBMITTING A TRAFFIC MANAGEMENT PLAN TO VICROADS, AND THE SUPERINTENDENT AND OBTAIN A MEMORANDIUM OF CONSENT. THE APPLICATION MUST BE SUBMITTED 14 DAYS PRIOR TO THE INTENDED PLACEMENT OF THE SPEED LIMIT.
- THE CONTRACTOR SHALL GIVE TWO (2) DAYS CLEAR NOTICE OF INTENTION TO COMMENCE WORKS TO THE AFFECTED RESIDENTS AND TO COUNCIL. THE CONTRACTOR IS TO ARRANGE FOR INSPECTION OF EXISTING PRIVATE PROPERTY AND THE ROADWAY, WHERE NECESSARY, TO ASSESS EXISTING DAMAGE. THE CONTRACTOR WILL BE LIABLE FOR THE REPAIR OF ANY NEW DAMAGE AS A RESULT OF THESE CONSTRUCTION WORKS.
- 1.10. ANY DIFFERENCES BETWEEN THE PLANS AND EXISTING CONDITIONS ARE TO BE REPORTED IMMEDIATELY TO THE WORKS SUPERINTENDENT.
- 1.11. ALL SURPLUS MATERIAL IS THE PROPERTY OF THE CONTRACTOR AND SHALL BE REMOVED AND DISPOSED BY THE CONTRACTOR TO THE SATISFACTION OF THE WORKS SUPERINTENDENT.
- 1.12. NO TREES ARE TO BE REMOVED OTHER THAN THOSE AS INDICATED ON THE PLANS.
- 1.13. THE CONTRACTOR IS TO TAKE EXTREME CARE WHEN EXCAVATING NEAR TREES TO AVOID ROOT DAMAGE. ANY REMOVAL (IF NOT INDICATED ON PLANS), TRIMMING OR ALTERATIONS TO EXISTING TREES MUST HAVE THE APPROVAL OF THE WORKS SUPERINTENDENT
- 1.14. THE CONTRACTOR IS TO CAREFULLY REMOVE AND REINSTATE ANY STREET FURNITURE, SIGNS ETC., AS REQUIRED TO CARRY OUT THE WORKS.
- 1.15. THE CONTRACTOR IS TO REINSTATE THE EXISTING ROADWAY, DRIVEWAYS, FOOTPATHS, KERBS, FENCES ETC., TO COUNCIL STANDARDS AND DETAILS PROVIDED AND TO THE SATISFACTION OF THE WORKS SUPERINTENDENT.
- 1.16. ON THE COMPLETION OF WORKS, THE SITE IS TO BE CLEANED UP TO THE SATISFACTION OF THE WORKS SUPERINTENDENT.
- 1.17. ALL NATURE STRIPS ARE TO BE REINSTATED WITH 100mm MIN. DEPTH LOAM AND SEEDED TO THE SATISFACTION OF THE WORKS SUPERINTENDENT.
- THE CONTRACTOR MUST COMPLY WITH THE OCCUPATIONAL HEALTH & SAFETY CODE OF PRACTICE 1997 ON CONFINED SPACED AND THE OCCUPATIONAL HEALTH AND SAFETY (CONFINED SPACES) REGULATIONS 1996.

2. DRAINAGE

- 2.1. CONSTRUCT NEW DRAINAGE SYSTEMS AS SHOWN. REFER TO PIT SCHEDULE AND DRAINAGE LONG SECTIONS FOR ALL DRAINAGE DETAILS.
- LOCATION, INVERT LEVELS AND ALIGNMENT OF EXISTING PITS AND PIPES AND SURFACE LEVELS ARE TO BE CONFIRMED BY THE CONTRACTOR AND PRIOR TO CONSTRUCTION.
- 2.3. PRECAST PITS TO HAVE 100MM MIN. THICK WALLS AND CAST INSITU PITS TO HAVE 150MM THICK WALL UNLESS OTHERWISE STATED.
- ALL PIPES TO BE CLASS 2 REINFORCED CONCRETE RUBBER RING JOINTED, UNLESS OTHERWISE STATED, LAID IN ACCORDANCE WITH COUNCIL SPECIFICATIONS. PIPE TRENCHES TO BE BACKFILLED TO DETAILS PROVIDED AND TO THE SATISFACTION TO THE WORKS SUPERINTENDENT.
- 2.5. ALL EXISTING PROPERTY STORMWATER OUTLETS WITHIN 3.0 m OF THE NEW DRAIN ARE TO BE CONNECTED TO THE UNDERGROUND DRAINAGE PIPES WHERE AVAILABLE.
- NEW DRAINAGE PITS ARE TO BE PLACED USING THE SET OUT CO-ORDINATES PROVIDED AND PROPERLY ALIGNED TO ENSURE THE FLOW IS GUIDED DIRECTLY TO THE OUTLET. IF THIS CANNOT BE ACHIEVED VERTICAL DEFLECTORS MUST BE PROVIDED.
- 2.7. THE CONTRACTOR IS TO COMPLY WITH THE REQUIREMENTS OF THE MINES (TRENCHES) REGULATIONS 1982 WHICH INCLUDES NOTIFICATION TO THE SECRETARY OF MINERALS AND ENERGY OF INTENTION TO WORK IN TRENCHES IN EXCESS OF 1.5 m DEEP. A COPY OF THE NOTIFICATION, ON THE APPROVED FORM, IS TO BE RECEIVED BY COUNCIL'S WORKS SUPERINTENDENT THREE (3) DAYS PRIOR TO THE COMMENCEMENT OF SUCH WORKS. A FOREMAN QUALIFIED AS A NOMINATED MINES MANAGER MUST BE IN ATTENDANCE AT ALL TIMES DURING THESE EXCAVATIONS.
- 2.8. ANCHOR BLOCKS TO COUNCIL STANDARD ARE TO BE PROVIDED ON ALL PIPELINES IN EXCESS OF 1 IN 10 (10%) GRADE AT A MIN. OF 9M INTERVALS.

3. <u>CONCRETE</u>

- 3.1. ALL CONCRETE WORKS SHALL BE IN ACCORDANCE WITH **DARWIN CITY COUNCIL** STANDARDS UNLESS OTHERWISE STATED.
- 3.2. REINFORCEMENT FABRIC SHALL COMPLY WITH AS 1304 AND SHALL BE CONTINUOUS BETWEEN WALLS. SLABS AND COPING BEAMS. CORNER RETURNS REINFORCEMENT MAY BE FABRIC OR EQUIVALENT BARS. LAPS TO BE 300 mm MIN. FOR FABRIC AND BARS. CLEAR COVER TO BE 50 mm MIN
- 3.3. REINFORCEMENT BARS SHALL COMPLY WITH AS 1302, GRADE 400Y. CLEAR COVER TO BE 50 mm MIN. LAPS TO BE 25 TIMES BAR DIAMETER.
- 3.4. EXPOSED CONCRETE EDGES TO HAVE 20 mm CHAMFER.
- 3.5. ALL CONCRETE SHALL HAVE COMPRESSIVE STRENGTH OF 25 MPA MIN. AT 28 DAYS CEMENT CONTENT SHALL BE AT LEAST 320 kg/m³ OF CONCRETE.
- 3.6. TESTING AND ASSESSMENT OF CONCRETE TO BE IN ACCORDANCE WITH AS 3600 CONCRETE STRUCTURES.
- 3.7. ALL WALLS SHALL BE SUITABLY PROPPED DURING & AFTER PLACEMENT AND AFTER COMPACTION OF BACKFILL. PROPS SHALL ONLY BE REMOVED AFTER COPING BEAMS, SLABS AND WALLS HAVE BEEN POURED AND CURED FOR 7 DAYS MIN. BACKFILL NEXT TO WALLS TO BE LIGHTLY COMPACTED ONLY.

4. <u>STEELWORK</u>

- 4.1. ALL MATERIALS SHALL HAVE STRUCTURAL QUALITY IN ACCORDANCE WITH AS 3678 GRADE 250.
- 4.2. ALL STEELWORK TO COMPLY WITH AS 1250 STEEL STRUCTURES CODE.
- 4.3. REMOVE ALL BURRS AND SHARP EDGES FROM CORNERS.
- 4.4. ALL FABRICATION TOLERANCES SHALL BE WITHIN ± 1.0 mm AND ALL ANGULAR TOLERANCES SHALL BE WITHIN ± 1°, UNLESS OTHERWISE STATED.
- 4.5. ALL WELDS TO BE 6 mm CONTINUOUS FILLET WELDS IN ACCORDANCE WITH AS 1554 PART 1 UNLESS OTHERWISE STATED.
- 4.6. ALL FABRICATED STEEL WORK TO BE HOT DIP GALVANISED AFTER FABRICATION.
- 4.7. PROVIDED SUITABLE HOLES AS REQUIRED FOR GALVANISING.
- 4.8. ALL FIXTURES AND FITTINGS TO BE HOT DIP GALVANISED.

5. <u>EXTERNAL MEDIUM DUTY CONCRETE PAVEMENTS</u>

- 5.1. ALL EXTERNAL TRAFFICABLE CONCRETE PAVEMENTS TO HAVE MINIMUM CONCRETE COMPRESSIVE STRENGTH OF 32 MPA.
- 5.2. PAVEMENT COMPOSITION AS SHOWN ON DETAILS.
- 5.3. SUBGRADE TO BE PREPARED IN ACCORDANCE WITH RELEVANT GEOTECHNICAL REPORT. AS A MINIMUM SUBGRADE IS TO BE PROOF ROLLED AND SOFT SPOTS REMOVED AND FILLED USING CRUSHED ROCK COMPACTED AS REQUIRED.
- 5.4. PLACE CONCRETE USING AN ACCEPTED VIBRATION METHOD. ALL REINFORCEMENT IS TO BE PLACED ON SUPPORT CHAIRS SPACED TO MINIMISE SAG.
- UNLESS SPECIFIED OTHERWISE ALL SURFACE FINISHES TO BE NON-SLIP STIPPLE FINISH.
- 5.6. ALL PAVEMENTS TO BE CURED IN ACCORDANCE WITH CURRENT INDUSTRY PRACTICE AND AS SPECIFIED IN AS3600.
- 5.7. ALL JOINTS TO BE SEALED WITH FLEXIBLE WATERPROOF SEALANT OVER.
- 5.8. ALL SLAB EDGES TO BE THICKENED IN ACCORDANCE WITH ATTACHED DETAIL.
- WHEN CONCRETE FINISHES AGAINST EXISTING STRUCTURES, PROVIDE 10 mm ABELFLEX SEPARATOR AND FLEXIBLE SEALANT OVER.

6. <u>AG-DRAINS</u>

- 6.1. AG-DRAINS (SUBSOIL DRAINS) ARE TO BE INSTALLED IN ACCORDANCE WITH AS 3500.
- MINIMUM GRADE OF AG-DRAINS IS TO BE 1:200.
- 6.3. AG-DRAINS ARE TO BE FITTED WITH ϕ 150 INSPECTION OPENINGS (I.O.) AT THEIR TOPMOST ENDS, AT CHANGES OF FLOW DIRECTIONS AND AT A MAXIMUM HORIZONTAL DISTANCE OF 45 m.
- 6.4. INSPECTION OPENINGS ARE TO EXTEND VERTICALLY TO THE TOP OF A PAVED AREA OR WITHIN 300 mm FROM THE SURFACE IN UNPAVED AREAS AND TERMINATED WITH A SCREW CAP LEGIBLY MARKED 'SW'. ADEQUATE CAST IRON PROTECTION COVERS ARE TO BE USED WHEN POSITIONED WITHIN TRAFFIC LANES OR PAVEMENT WITH VEHICLE ACCESS.
- 6.5. THE CONTRACTOR IS TO ALLOW FOR ALL AG-DRAINS AS REQUIRED AT THE BACK OF PROPOSED KERB
- 6.6. ALL AG-DRAINS ARE TO BE WRAPPED IN GEOTEXTILE MATERIAL OR THE ENTIRE BEDDING MATERIAL IS TO BE WRAPPED WITH GEOTEXTILE FABRIC OVERLAPPING NOT LESS THAN 300 mm.
- 6.7. UNLESS NOTED OTHERWISE, THE EMBEDMENT MATERIAL IS TO BE Ø10 mm NOM. CLEAN SCREENINGS FOR THE FULL DEPTH OF THE EMBEDMENT TRENCH
- 6.8. AG DRAINS TO BE INSTALLED 300 mm MINIMUM BELOW PERMEABLE SOIL LAYER.
- 6.9. ANY EXISTING SUB SURFACE DRAINS ARE TO BE RETAINED. ANY DAMAGE DONE TO EXISTING SUB SURFACE DRAINS ARE TO BE REPAIRED. ENSURE THAT THE EXISTING SUB SURFACE DRAINS ARE NOT BLOCKED AND FLOW TO A POINT OF DISCHARGE.

7. <u>JUNCTION TO EXISTING WORKS</u>

- 7.1. LEVELS OF EXISTING COVERS SHALL BE ADJUSTED TO SUIT DESIGN LEVELS (IF REQUIRED).
- 7.2. PRIOR TO WORKS COMMENCING, THE CONTRACTOR SHALL NOTIFY THE PROPERTY OWNERS OF INTENDED WORKS.
- 7.3. ALL NEW WORK SHALL NEATLY MATCH TO EXISTING SURROUNDS. CONTRACTOR SHALL MAKE GOOD AREAS NOT COVERED UNDER THESE SITE WORKS THAT HAVE BEEN DISTURBED.

8. <u>HEALTH AND SAFETY</u>

- 8.1. IT IS THE RESPONSIBILITY OF THE CONTRACTOR TO ENSURE ALL WORKS ARE CARRIED OUT IN A SAFE MANNER. THE WORKS SHALL COMPLY WITH APPLICABLE HEALTH AND SAFETY LEGISLATION INCLUDING CODES OF PRACTICE, AUSTRALIAN STANDARDS, GUIDANCE NOTES AND WORKSAFE
- 8.2. THE CONTRACTOR SHALL ENSURE A RISK ASSESSMENT HAS BEEN CARRIED OUT AND DOCUMENTED FOR ALL ACTIVITIES PERFORMED ON THE SITE. SAFE WORK PROCEDURES MUST BE DOCUMENTED AS REQUIRED BY LEGISLATION AND RELEVANT AUTHORITIES. THE BUILDER MAY NEED TO ENGAGE SUITABLY EXPERIENCED CONSULTANTS TO PREPARE A SAFE WORK PROCEDURE IF THE BUILDER IS INEXPERIENCED IN THIS FIELD OR IF THEY ARE NOT SATISFIED WITH THE METHOD PROPOSED BY THE CONTRACTOR.

9. <u>AUXILIARY WORKS</u>

- 9.1. THE CONTRACTOR IS TO SEEK COUNCIL REQUIREMENTS FOR 'NOTICES OF WORKS' WITHIN A PUBLIC ROAD RESERVE.
- 9.2. NO ROAD WORKS ARE TO COMMENCE UNTIL ALL TEMPORARY SIGNS AND ASSOCIATED ITEMS ARE IN PLACE AS APPROVED.
- 9.3. ALL DISTURBED AREAS ARE TO BE REINSTATED AND SHAPED AS DIRECTED. ALL GRASSED AREAS SHALL BE TOP DRESSED WITH A MINIMUM DEPTH OF 75 mm OF APPROVED TOPSOIL, RAKED AND
- 9.4. ALL ROADSIDE AREAS SHALL BE MAINTAINED FOR A MINIMUM OF THREE MONTHS OR UNTIL THEY ARE RE-ESTABLISHED TO COUNCIL SATISFACTION.
- 9.5. MAINTENANCE WORKS SHALL INCLUDE BUT NOT TO BE LIMITED TO:
- TOPPING UP WITH SOIL WHERE SUBSIDED
- 9.5.2. RE-SEEDING AS REQUIRED.
- MOWING AND GENERAL LANDSCAPE MAINTENANCE.
- ALL LINE MARKING TO BE IN ACCORDANCE WITH COUNCIL GUIDELINES.
- 9.6. REINSTATE ANY PATHS, KERBS, PAVEMENTS, BATTERS AND RETAINING WALLS DAMAGED DURING THE COURSE OF THE WORKS TO THE SATISFACTION OF THE CLIENT REPRESENTATIVE.

10. EROSION CONTROL PLAN

10.1. AN EROSION CONTROL PLAN IS TO BE IMPLEMENTED ON SITE DURING CONSTRUCTION TO PREVENT SEDIMENT FROM LEAVING THE SITE AND ENTERING THE DRAINAGE SYSTEM.. I.E. HAY BALES WITH GEOFABRIC MATERIAL TO THE SATISFACTION OF THE RELEVANT AUTHORITY.

161711	-	-	-	-	-			
<21085	-	-	-	-	-			
×××	-	-	-	-	-			
7:/Z	-	-	-	-	-			Consulting
HIUN:	А	08/04/2021	ISSUED FOR REVIEW	J.L.	J.G.			ADDRESS: SUITE 704, 1 PR
E LUL/	REV	DATE	DESCRIPTION	DRAWN	APP'D	No	DRAWING NUMBER REFERENCE DRAWING TITLE	STREET, KEW, N PHONE: 03 9853 1218
				<u> </u>	I		1	I

onsulting Engineers ESS: SUITE 704, 1 PRINCESS

STREET, KEW, VIC, 3101

COPYRIGHT OF THIS DRAWING IS VESTED IN G&P CONSU NGINEERS AND THIS DRAWING/FILE IS NOT TO BE REPR OR COPIED IN WHOLE OR IN PART, IN ANY FORM, WITHOU RIOR WRITTEN APPROVAL OF G&P CONSULTING ENGINE HE RECIPIENT IS RESPONSIBLE FOR ENSURING THAT TH REVIEW THE STATUS OF THIS DRAWING, AND ARE IN REC THE CURRENT REVISION PRIOR TO USE. EXCEPT WHERE DIMENSIONS HAVE BEEN PROVIDED, G&P CONSULTING ENGINEERS IS NOT RESPONSIBLE FOR DIMENSIONING AND SETTING OUT. THIS DRAWING HAS NOT BEEN PRODUCED LEVEL OF DIMENSIONAL ACCURACY SUITABLE FOR FABR THE CONTRACTOR IS RESPONSIBLE FOR PRODUCTION OF EABRICATION / SHOP DRAWINGS WHERE THESE ARE REC THIS DRAWING HAS BEEN REPRODUCED FOR THE NAMED. FOR USE ON THIS PROJECT ONLY AND IS NOT TO BE USE

ILTING	CLIENT	
RODUCED JT THE EERS. HEY	LOUW GROUP	
CEIPT OF FIGURED	PROJECT	
TO A RICATION.	PROPOSED TOWNHOUSE DEVELOPMENT - CIVIL DESIGN	
QUIRED.	PROJECT ADDRESS	
CLIENT ED FOR	LOT 1257–1259 RAPID CREEK ROAD, RAPID CREEK, NT	

DRAWING TITLE GENERAL NOTES (1 OF 2) 2108 DRAWING CHECK DRAWING REFERENCE REVISION DRAWN J.L. J.G. DESIGN CHECK DESIGNED REF. J.G. J.L. SCALE AS SHOWN AT A1

SEDIMENT AND EROSION CONTROL NOTES

11. **GENERAL NOTES**

- 11.1. SOIL CONTROL MEASURES MUST BE ADOPTED AT ALL TIMES TO THE SATISFACTION OF COUNCIL'S DESIGN ENGINEER AND THE FACILITIES MANAGER DURING THE DURATION OF THE CONTRACT. SITE CONTROLS AND EROSION MINIMISATION TECHNIQUES ARE TO BE IN ACCORDANCE WITH THE INSTITUTE OF ENGINEERS AUSTRALIA PUBLICATION 'SOIL EROSION AND SEDIMENT CONTROL', EPA GUIDELINES AND OTHER CONTRACT DOCUMENTATION INCLUDING THIS PLAN.
- 11.2. SITE ESTABLISHMENT AND STRIPPING TOPSOIL:
- 11.2.1. STOCKPILE SOIL IN ALLOCATED LOCATION AND PROVIDE SILT CONTROL BARRIERS IF STOCKPILE IS LEFT OVERNIGHT.
- WASH DOWN ANY VEHICLES LEAVING SITE AFTER TREADING ON SOIL
- 11.2.3. PLACE CRUSHED ROCK TO A DEPTH OF 150 mm MINIMUM TO ALL VEHICLE ACCESS AREAS OVER AN APPROVED WOVEN GEOTEXTILE FABRIC (DUX W155 OR EQUIVALENT).
- GRADE ALL SOIL AREAS AWAY FROM MAIN CONSTRUCTION AREA AND TOWARDS DRAINAGE POINTS.
- PLACE FILTER MATERIAL SUCH AS HAY BALES OR SILT FENCES AROUND DRAINAGE POINTS.
- 11.2.6. INSTALL ON-SITE WASTE RECEPTORS (I.E. MINI-SKIPS, BINS, WIND PROOF LITTER RECEPTORS). 11.3. CONSTRUCTION OF DRAINAGE SYSTEM:
- 11.3.1. CARRY OUT WORKS IN DRY WEATHER.
- 11.3.2. DO NOT LEAVE TRENCHES OPEN FOR A LONG PERIOD OF TIME.
- 11.3.3. BUILD DRAINAGE SYSTEM COMMENCING FROM DOWN STREAM.
- 11.3.4. PLACE FILTER MATERIAL IN EXISTING DOWNSTREAM, UNTIL ALL DRAINAGE IS IN PLACE AND THEN INSTALL SILT CONTROL DEVICES AT EACH NEW PIT.
- 11.4. CONSTRUCTION OF MAIN WORKS:
- 11.4.1. ENSURE THAT SOIL IS KEPT MOIST TO MINIMISE AIR POLLUTION.
- 11.4.2. DO NOT LEAVE SOIL EXPOSED FOR LONG PERIODS OF TIME.
- 11.4.3. ENSURE FALLS OF CUT OR FILL ARE AWAY FROM MAIN WORKING AREA.
- 11.4.4. INSTALL ROOF DOWNPIPES AS SOON AS PRACTICABLE IF NECESSARY, USE TEMPORARY CONNECTIONS TO ENSURE STORMWATER DOES NOT DISCHARGE OVER LOOSE SOIL.
- 11.5. LANDSCAPING
- 11.5.1. PLACE VEGETATION SUITABLE TO MINIMISE LOOSE SOIL CONDITIONS. REFER TO THE APPROVED LANDSCAPING PLAN FOR ADDITIONAL INFORMATION.

12. TREATMENT DEVICES

- 12.1. SEDIMENT FENCES:
- SEDIMENT FENCES ARE TO BE PLACED AS REQUIRED. THEY CONSIST OF GEOTEXTILE FILTER FABRIC STAPLED ONTO 40 mm SQUARE HARDWOOD STAKES OR WIRE TIED TO STEEL POSTS. THE FILTER FABRIC MUST BE BURIED 100 mm MIN. INTO THE GROUND AND STAND UP TO A HEIGHT OF 700 mm. POSTS ARE TO BE SPACED AT 2.0 m CENTRES AND DRIVEN 600 mm INTO THE GROUND. WHEN STOCKPILING GRANULAR MATERIAL INCLUDING TOP SOILS. A SEDIMENT FENCE SHOULD BE ERECTED AT THE PERIMETER OF THE STOCKPILE IF LEFT OVERNIGHT
- 12.2. PROTECTION OF DRAINAGE POINTS:
- 12.2.1. ALL DRAINAGE POINTS, WHETHER TEMPORARY OR PERMANENT, SHALL BE PROTECTED FROM POLLUTED WATERS. THE PRINCIPLE CONTRACTOR MAY USE STRAW BALES HELD IN PLACE BY AT LEAST TWO DRIVEN PICKETS OR SEDIMENT FENCES TO FULLY SURROUND THE DRAINAGE PIT.
- 12.3. GENERAL BUILDING OPERATIONS:
- 12.3.1. BUILDING OPERATIONS SUCH AS WASHING OF TOOLS AND PAINTING EQUIPMENT, CUTTING MASONRY OR THE USE OF ANY OTHER WATER COOLED CUTTING EQUIPMENT SHOULD BE CARRIED OUT IN A CONTROLLED AREA, WHERE POSSIBLE ON A NATURAL FILTERED AREA SUCH AS A GRASSED TRENCH, OR IN THE VICINITY OF A SEDIMENT SETTLING TANK.
- 12.4. VEHICLE ENTRY/EXIT POINTS:
- 12.4.1. ALL VEHICLE ENTRY/EXIT POINTS ARE TO BE TREATED WITH CRUSHED ROCK OVER AN APPROVED WOVEN GEOTEXTILE FABRIC (DUX W155 OR EQUIVALENT), WELL COMPACTED AND ADJACENT TO THE EXIT DRIVEWAY. THE PRINCIPLE CONTRACTOR IS TO PROVIDE SUITABLE WASHING FACILITIES FOR CLEANING OF ALL VEHICLES PRIOR TO THEM EXITING THE SITE SO AS TO PREVENT ANY GREASE, OIL, MUD, CLAY OR OTHER SUBSTANCES FALLING OR RUNNING OFF A VEHICLE ON THE ROAD PAVEMENT OR INTO ANY DRAIN. THE CONDITION OF THE SITE ACCESS/EGRESS IS TO BE CONTINUOUSLY MONITORED AND CLEANED DOWN AS NECESSARY DURING THE COURSE OF THE CONTRACT TO MAINTAIN CLEAN FOOTPATHS AND ROADWAYS.

13. <u>ADDITIONAL NOTES FOR SEDIMENT AND EROSION CONTROL</u>

- 13.1. THE CONTRACTOR IS RESPONSIBLE FOR THE ESTABLISHMENT AND MAINTENANCE OF ALL EROSION AND SEDIMENT CONTROL MEASURES TO SUCH TIME THAT THE PROJECT IS COMPLETED AND OFFICIALLY HANDED OVER TO THE CLIENT. THIS MAY INCLUDE THE PROVISION OF TEMPORARY DRAINAGE AND WATER QUALITY MANAGEMENT DEVICES.
- 13.2. DO NOT STRIP OR EXCAVATE SITE UNTIL BUILDING WORKS ARE READY TO PROCEED
- 13.3. OBTAIN ALL NECESSARY PERMITS, LICENSES AND APPROVALS, REFER TO COUNCIL APPROVED DRAWINGS AND DOCUMENTATION.
- 13.4. ESTABLISH ALL REQUIRED ENTRY/EXIT POINTS AND TREAT THESE AREAS AS DESCRIBED ABOVE.
- 13.5. STACK SOILS IN PRE-DEFINED EROSION CONTROL AREAS, WHEN LEFT OVER NIGHT
- 13.6. ACCIDENTAL SPILLS OF SOIL OR OTHER MATERIAL ONTO THE ROAD OR INTO THE GUTTER OR DRAIN SHOULD BE REMOVED PRIOR TO STORMS AND AT LEAST UPON COMPLETION OF THE DAYS WORK. MATERIALS SHOULD BE SWEPT OFF THE ROAD AND NOT WASHED DOWN THE GUTTER.
- 13.7. EROSION CONTROL DEVICES SHOULD BE INSPECTED REGULARLY AND AFTER EVERY STORM EVENT
- 13.8. CONCRETE WASTE FROM TRUCKS AND MIXERS SHOULD BE CONTAINED ON-SITE AND NOT DISPOSED OF. DOWN A DRAIN OR IN ANY OTHER WAY WHICH MAY BE CONSIDERED HARMFUL TO THE ENVIRONMENT

-	-	-	-	-				
-	-	-	-	-				
-	-	-	-	-				
-	-	-	-	-				Consulting Engi
А	08/04/2021	ISSUED FOR REVIEW	J.L.	J.G.				ADDRESS: SUITE 704, 1 PRINCESS STREET, KEW, VIC, 3101
REV	DATE	DESCRIPTION	DRAWN	APP'D	No	DRAWING NUMBER	REFERENCE DRAWING TITLE	PHONE: 03 9853 1218

ENGINEERS AND THIS DRAWING/FILE IS NOT TO BE OR COPIED IN WHOLE OR IN PART, IN ANY FORM, WIT PRIOR WRITTEN APPROVAL OF G&P CONSULTING EN THE RECIPIENT IS RESPONSIBLE FOR ENSURING THA REVIEW THE STATUS OF THIS DRAWING, AND ARE I THE CURRENT REVISION PRIOR TO USE. EXCEPT WHE DIMENSIONS HAVE BEEN PROVIDED, G&P CONSULTIN g Engineers ENGINEERS IS NOT RESPONSIBLE FOR DIMENSIONING SETTING OUT. THIS DRAWING HAS NOT BEEN PRODU LEVEL OF DIMENSIONAL ACCURACY SUITABLE FOR THE CONTRACTOR IS RESPONSIBLE FOR PRODUCTION FABRICATION / SHOP DRAWINGS WHERE THESE ARE THIS DRAWING HAS BEEN REPRODUCED FOR THE NA FOR USE ON THIS PROJECT ONLY AND IS NOT TO BE ANY OTHER PURPOSE.

COPYRIGHT OF THIS DRAWING IS VESTED IN G&P CONSULTING	CLIENT	
ENGINEERS AND THIS DRAWING/FILE IS NOT TO BE REPRODUCED OR COPIED IN WHOLE OR IN PART, IN ANY FORM, WITHOUT THE PRIOR WRITTEN APPROVAL OF G&P CONSULTING ENGINEERS. THE RECIPIENT IS RESPONSIBLE FOR ENSURING THAT THEY	LOUW GROUP	
REVIEW THE STATUS OF THIS DRAWING, AND ARE IN RECEIPT OF THE CURRENT REVISION PRIOR TO USE. EXCEPT WHERE FIGURED	PROJECT	
DIMENSIONS HAVE BEEN PROVIDED, G&P CONSULTING ENGINEERS IS NOT RESPONSIBLE FOR DIMENSIONING AND SETTING OUT. THIS DRAWING HAS NOT BEEN PRODUCED TO A LEVEL OF DIMENSIONAL ACCURACY SUITABLE FOR FABRICATION. THE CONTRACTOR IS RESPONSIBLE FOR PRODUCTION OF	PROPOSED TOWNHOUSE DEVELOPMENT - CIVIL DESIGN	
	PROJECT ADDRESS	
FABRICATION / SHOP DRAWINGS WHERE THESE ARE REQUIRED. THIS DRAWING HAS BEEN REPRODUCED FOR THE NAMED CLIENT FOR USE ON THIS PROJECT ONLY AND IS NOT TO BE USED FOR ANY OTHER PURPOSE	LOT 1257-1259 RAPID CREEK ROAD, RAPID CREEK, NT	

			DRAWING TITLE		
		GENERAL	NOTES (2 OF 2)		
	DRAWN	DRAWING CHECK	DRAWING REFERENCE	REVISION	\propto
1	J.L.	J.G.			71085
	DESIGNED	DESIGN CHECK	1 () \	٨	l
	J.L.	J.G.		A	
		SCALE AS S	HOWN AT A1		



REV DATE

DESCRIPTION

DRAWN APP'D

DRAWING NUMBER


REFERENCE DRAWING TITLE

PHONE: 03 9853 1218

ANY OTHER PURPOSE.

SCALE AS SHOWN AT A1



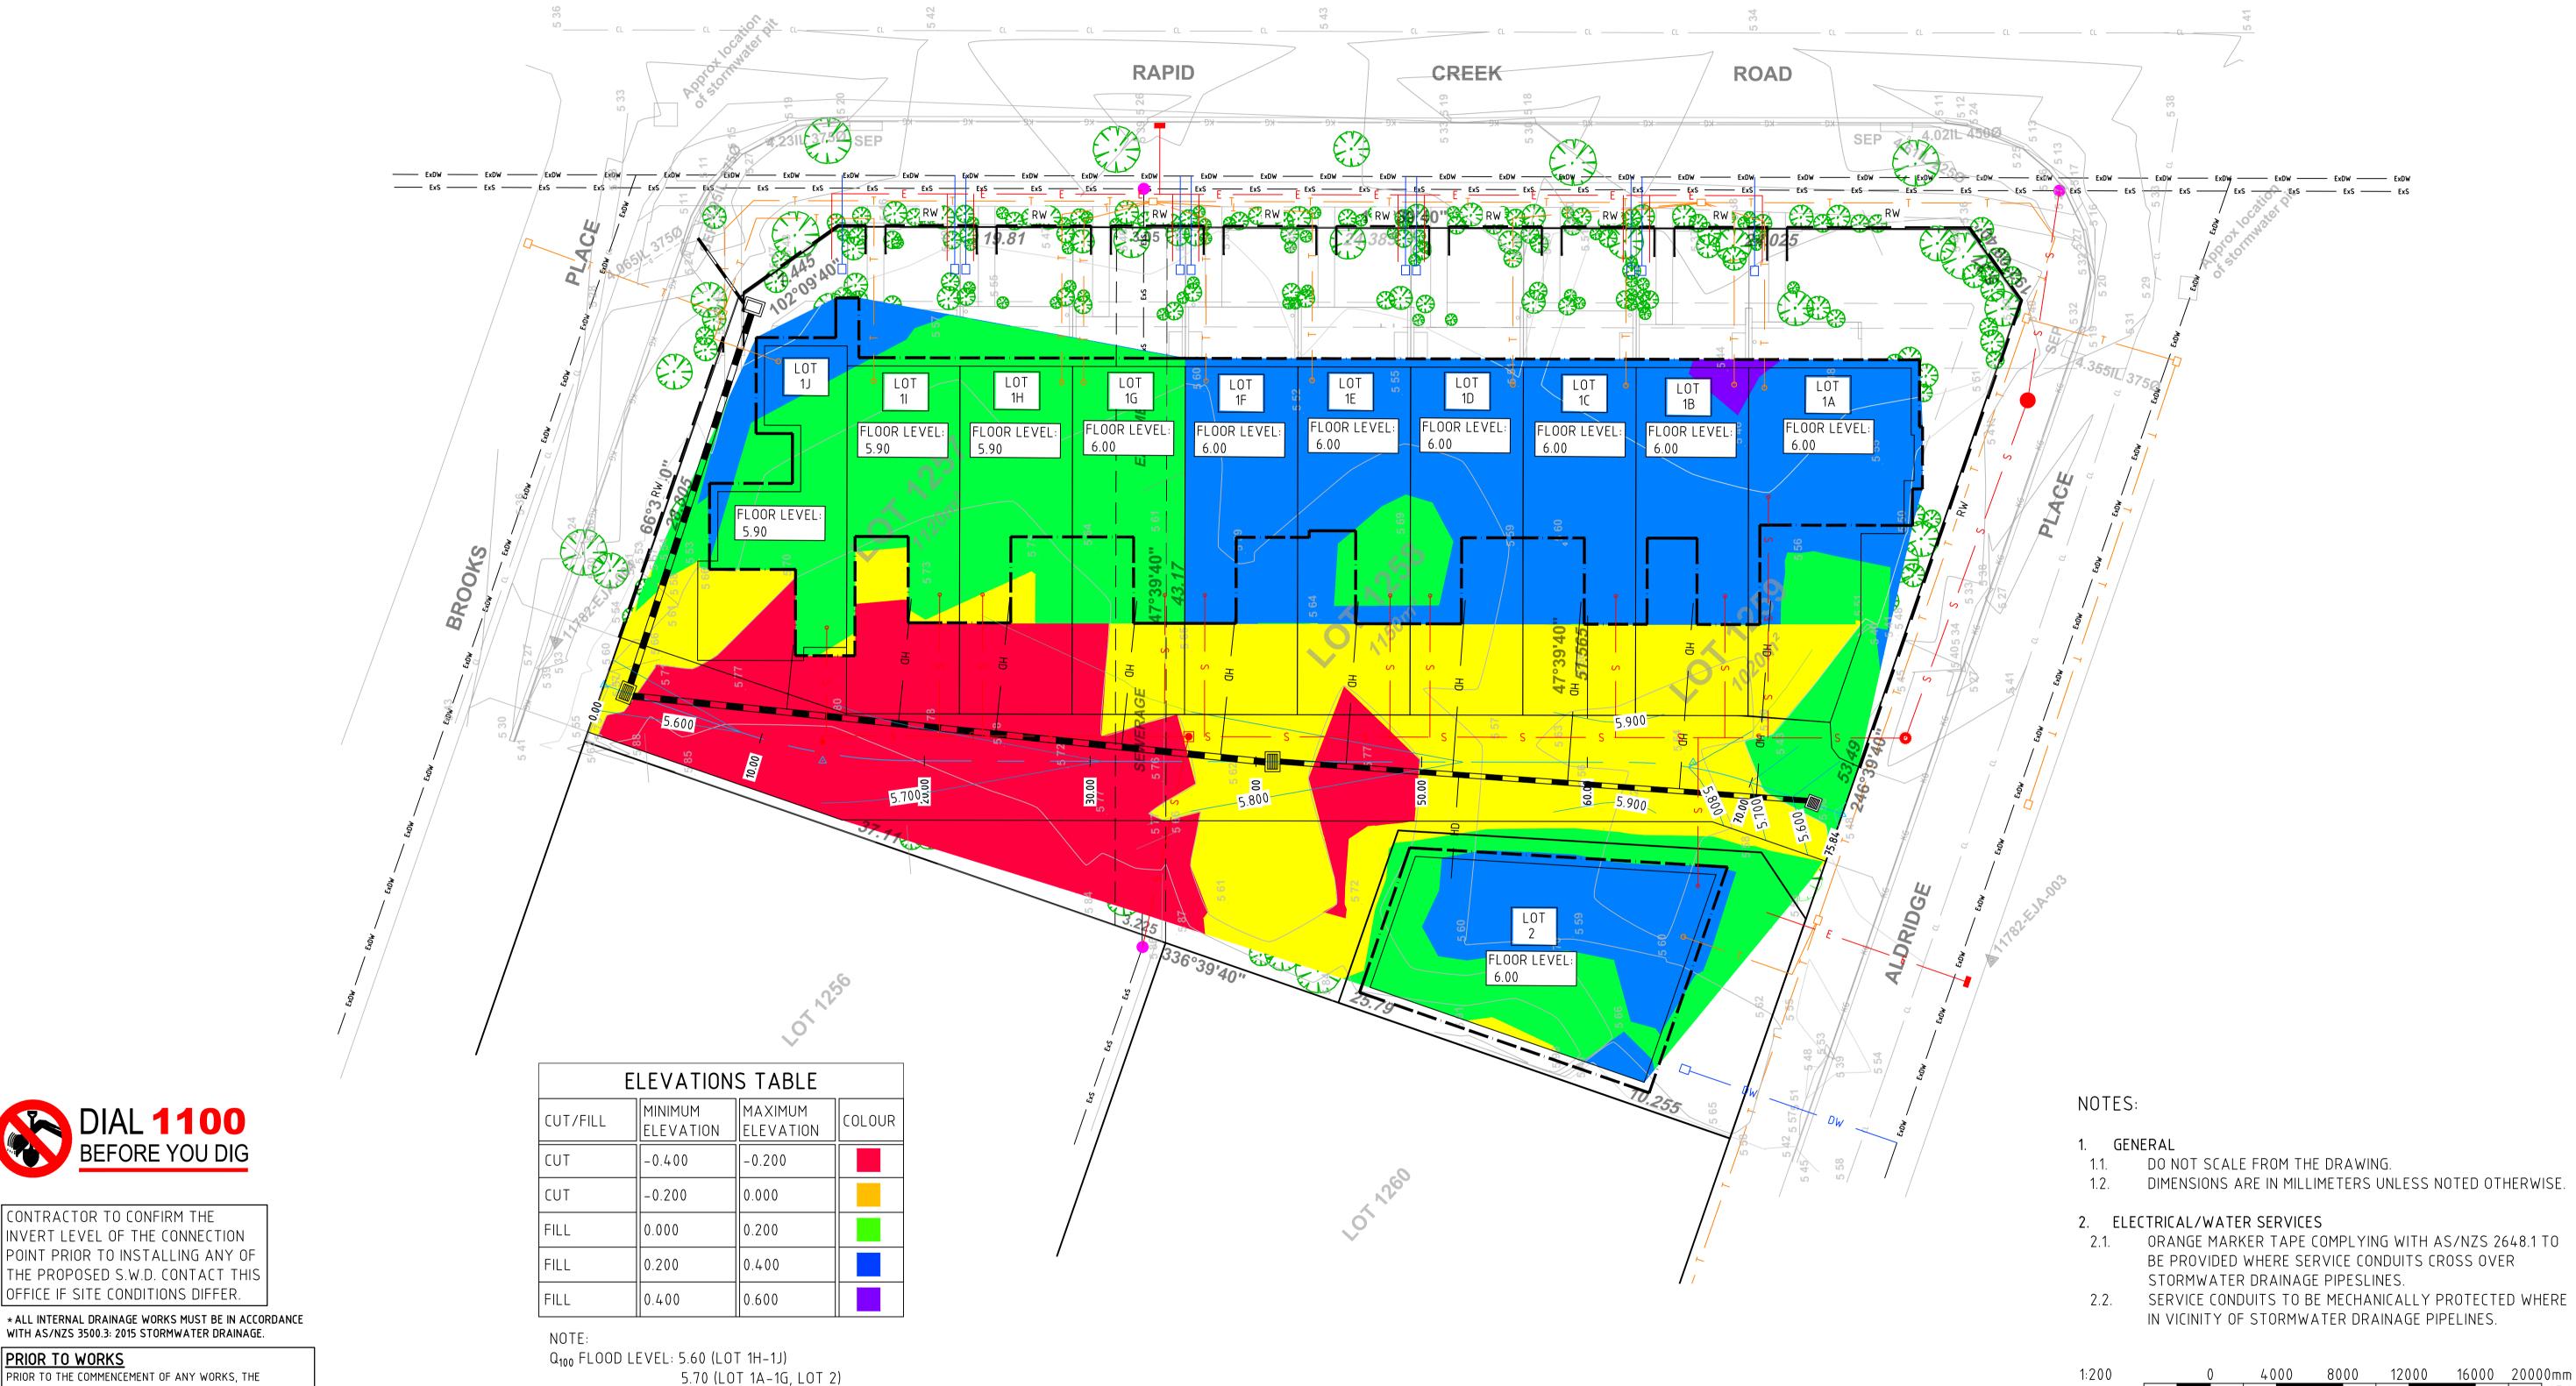

POINT PRIOR TO INSTALLING ANY OF

PRIOR TO WORKS

PRIOR TO THE COMMENCEMENT OF ANY WORKS, THE CONTRACTOR MUST VERIFY THAT ALL DRAWINGS HAVE BEEN CHECKED & APPROVED BY THE RELEVANT AUTHORITIES.

ISSUED FOR REVIEW

DESCRIPTION

J.G.

DRAWING NUMBER

DRAWN APP'D

DIAL 1100
BEFORE YOU DIG

CONTRACTOR TO CONFIRM THE

INVERT LEVEL OF THE CONNECTION

THE PROPOSED S.W.D. CONTACT THIS

WITH AS/NZS 3500.3: 2015 STORMWATER DRAINAGE.

OFFICE IF SITE CONDITIONS DIFFER.

Consulting Engineers

REFERENCE DRAWING TITLE

ADDRESS: SUITE 704, 1 PRINCESS STREET, KEW, VIC, 3101 PHONE: 03 9853 1218

COPYRIGHT OF THIS DRAWING IS VESTED IN G&P CONSULTING ENGINEERS AND THIS DRAWING/FILE IS NOT TO BE REPRODUCED OR COPIED IN WHOLE OR IN PART, IN ANY FORM, WITHOUT THE PRIOR WRITTEN APPROVAL OF G&P CONSULTING ENGINEERS. THE RECIPIENT IS RESPONSIBLE FOR ENSURING THAT THEY
REVIEW THE STATUS OF THIS DRAWING, AND ARE IN RECEIPT OF THE CURRENT REVISION PRIOR TO USE. EXCEPT WHERE FIGURED DIMENSIONS HAVE BEEN PROVIDED, G&P CONSULTING
ENGINEERS IS NOT RESPONSIBLE FOR DIMENSIONING AND
SETTING OUT. THIS DRAWING HAS NOT BEEN PRODUCED TO A LEVEL OF DIMENSIONAL ACCURACY SUITABLE FOR FABRICATION.
THE CONTRACTOR IS RESPONSIBLE FOR PRODUCTION OF FABRICATION / SHOP DRAWINGS WHERE THESE ARE REQUIRED.
THIS DRAWING HAS BEEN REPRODUCED FOR THE NAMED CLIENT FOR USE ON THIS PROJECT ONLY AND IS NOT TO BE USED FOR

ANY OTHER PURPOSE.

CLIENT
LOUW GROUP
PROJECT
PROPOSED TOWNHOUSE DEVELOPMENT - CIVIL DESIGN
PROJECT ADDRESS
LOT 1257-1259 RAPID CREEK ROAD, RAPID CREEK, NT

		RAWING TITLE	D	
S		VORKS (1 OF 2)	EARTHV	
8	REVISION	DRAWING REFERENCE	DRAWING CHECK	DRAWN
2108		$\mathcal{C} \cap \mathcal{C}$	J.G.	J.L.
		(() 5	DESIGN CHECK	ESIGNED
	A		J.G.	J.L.
		HOWN AT A1	SCALE AS SH	

A 08/04/2021 REV DATE





DIAL 1100
BEFORE YOU DIG

CONTRACTOR TO CONFIRM THE INVERT LEVEL OF THE CONNECTION POINT PRIOR TO INSTALLING ANY OF THE PROPOSED S.W.D. CONTACT THIS OFFICE IF SITE CONDITIONS DIFFER.

* ALL INTERNAL DRAINAGE WORKS MUST BE IN ACCORDANCE WITH AS/NZS 3500.3: 2015 STORMWATER DRAINAGE.

PRIOR TO WORKS

A 08/04/2021

REV DATE

PRIOR TO THE COMMENCEMENT OF ANY WORKS, THE CONTRACTOR MUST VERIFY THAT ALL DRAWINGS HAVE BEEN CHECKED & APPROVED BY THE RELEVANT AUTHORITIES.

ISSUED FOR REVIEW

DESCRIPTION

J.G.

DRAWING NUMBER

REFERENCE DRAWING TITLE

DRAWN APP'D

Consulting Engineers

ADDRESS: SUITE 704, 1 PRINCESS
STREET, KEW, VIC, 3101

PHONE: 03 9853 1218

COPYRIGHT OF THIS DRAWING IS VESTED IN G&P CONSULTING ENGINEERS AND THIS DRAWING/FILE IS NOT TO BE REPRODUCED OR COPIED IN WHOLE OR IN PART, IN ANY FORM, WITHOUT THE PRIOR WRITTEN APPROVAL OF G&P CONSULTING ENGINEERS. THE RECIPIENT IS RESPONSIBLE FOR ENSURING THAT THEY REVIEW THE STATUS OF THIS DRAWING, AND ARE IN RECEIPT OF THE CURRENT REVISION PRIOR TO USE. EXCEPT WHERE FIGURED DIMENSIONS HAVE BEEN PROVIDED, G&P CONSULTING ENGINEERS IS NOT RESPONSIBLE FOR DIMENSIONING AND SETTING OUT. THIS DRAWING HAS NOT BEEN PRODUCED TO A LEVEL OF DIMENSIONAL ACCURACY SUITABLE FOR FABRICATION. THE CONTRACTOR IS RESPONSIBLE FOR PRODUCTION OF FABRICATION / SHOP DRAWINGS WHERE THESE ARE REQUIRED. THIS DRAWING HAS BEEN REPRODUCED FOR THE NAMED CLIENT FOR USE ON THIS PROJECT ONLY AND IS NOT TO BE USED FOR ANY OTHER PURPOSE.

CLIENT	
LOUW GROUP	
PROJECT	
PROPOSED TOWNHOUSE DEVELOPMENT - CIVIL DESIGN	
PROJECT ADDRESS	
LOT 1257-1259 RAPID CREEK ROAD, RAPID CREEK, NT	

	D	RAWING TITLE				
	EARTHW	/ORKS (2 OF 2)		ک		
DRAWN	DRAWING CHECK	DRAWING REFERENCE	REVISION	α		
J.L.	J.G.	$C \cap C$		71085		
DESIGNED	DESIGN CHECK	Γ 06	Λ			
J.L.	J.G.	C 0 0	A			
SCALE AS SHOWN AT A1						

TILE LOCATION: TEXTIANA VZTVOS VLIVILICAD VZTVOS – KAPIU CIT

Ch 10.00 m DATUM RL4.50 DATUM RL4.70 DESIGN EXISTING ____ OFFSET Ch 0.00 m

DATUM RL4.60

DATUM RL4.60

DATUM RL4.60

DATUM RL4.50

Ch 40.00 m

Ch 30.00 m

Ch 20.00 m

<u>DA</u>TUM RL4.60

<u>**DA</u>TUM RL4.60**</u>

DATUM RL4.70

Ch 75.84 m

Ch 70.00 m

Ch 60.00 m

Ch 50.00 m

ENGINEERS AND THIS DRAWING/FILE IS NOT TO BE REPRODUCED OR COPIED IN WHOLE OR IN PART, IN ANY FORM, WITHOUT THE PRIOR WRITTEN APPROVAL OF G&P CONSULTING ENGINEERS. THE RECIPIENT IS RESPONSIBLE FOR ENSURING THAT THEY REVIEW THE STATUS OF THIS DRAWING, AND ARE IN RECEIPT OF FABRICATION / SHOP DRAWINGS WHERE THESE ARE REQUIRED.
THIS DRAWING HAS BEEN REPRODUCED FOR THE NAMED CLIENT
FOR USE ON THIS PROJECT ONLY AND IS NOT TO BE USED FOR ANY OTHER PURPOSE.

CLIENT	Ì
LOUW GROUP	
PROJECT	Ì
PROPOSED TOWNHOUSE DEVELOPMENT - CIVIL DESIGN	1
PROJECT ADDRESS	I
LOT 1257-1259 RAPID CREEK ROAD, RAPID CREEK, NT	

	DR	AWING TITLE		
	ACCESS RO	AD - SECTIONS		
DRAWN	DRAWING CHECK	DRAWING REFERENCE	REVISION	
J.L.	J.G.	<i>C</i> 0 <i>D</i>		
DESIGNED	DESIGN CHECK	(() /		
J.L.	J.G.	C 0 1	A	
	SCALE AS SHO	OWN AT A1		

NOTES:

0.457%

LONGITUDINAL SECTION Rapid Creek Ch 0.000 to Ch 70.798 SCALES: HORIZONTAL 1:250 VERTICAL 1:25

GENERAL

- 1.1. DO NOT SCALE FROM THE DRAWING.
- 1.2. DIMENSIONS ARE IN MILLIMETERS UNLESS NOTED OTHERWISE.

10.149

-3.749%

- 2. ELECTRICAL/WATER SERVICES
- 2.1. ORANGE MARKER TAPE COMPLYING WITH AS/NZS 2648.1 TO BE PROVIDED WHERE SERVICE CONDUITS CROSS OVER
- STORMWATER DRAINAGE PIPESLINES. 2.2. SERVICE CONDUITS TO BE MECHANICALLY PROTECTED WHERE IN VICINITY OF STORMWATER DRAINAGE PIPELINES.

-	-	-	-	-			
-	-	-	ı	-			AT CRD
-	-	-	ı	-			Consulting Engineer
-	-	-	ı	-			Consulting Engineer
Α	08/04/2021	ISSUED FOR REVIEW	J.L.	J.G.			ADDRESS: SUITE 704, 1 PRINCESS STREET, KEW, VIC, 3101
REV	DATE	DESCRIPTION	DRAWN	APP'D No	DRAWING NUMBER	REFERENCE DRAWING TITLE	PHONE: 03 9853 1218

COPYRIGHT OF THIS DRAWING IS VESTED IN G&P CONSULTING THE CURRENT REVISION PRIOR TO USE. EXCEPT WHERE FIGURED DIMENSIONS HAVE BEEN PROVIDED, G&P CONSULTING ENGINEERS IS NOT RESPONSIBLE FOR DIMENSIONING AND SETTING OUT. THIS DRAWING HAS NOT BEEN PRODUCED TO A LEVEL OF DIMENSIONAL ACCURACY SUITABLE FOR FABRICATION.
THE CONTRACTOR IS RESPONSIBLE FOR PRODUCTION OF


R.L. 3.900

SURFACE

EXISTING SURFACE

CHAINAGE

DRAWING TITLE							
ACCESS ROAD - SECTIONS							
DRAWN	DRAWING CHECK	DRAWING REFERENCE	REVISION				
J.L.	J.G.	$C \wedge \Box$					
DESIGNED	DESIGN CHECK	(() /	\				
J.L.	J.G.		A				
	SCALE AS S	HOWN AT A1					

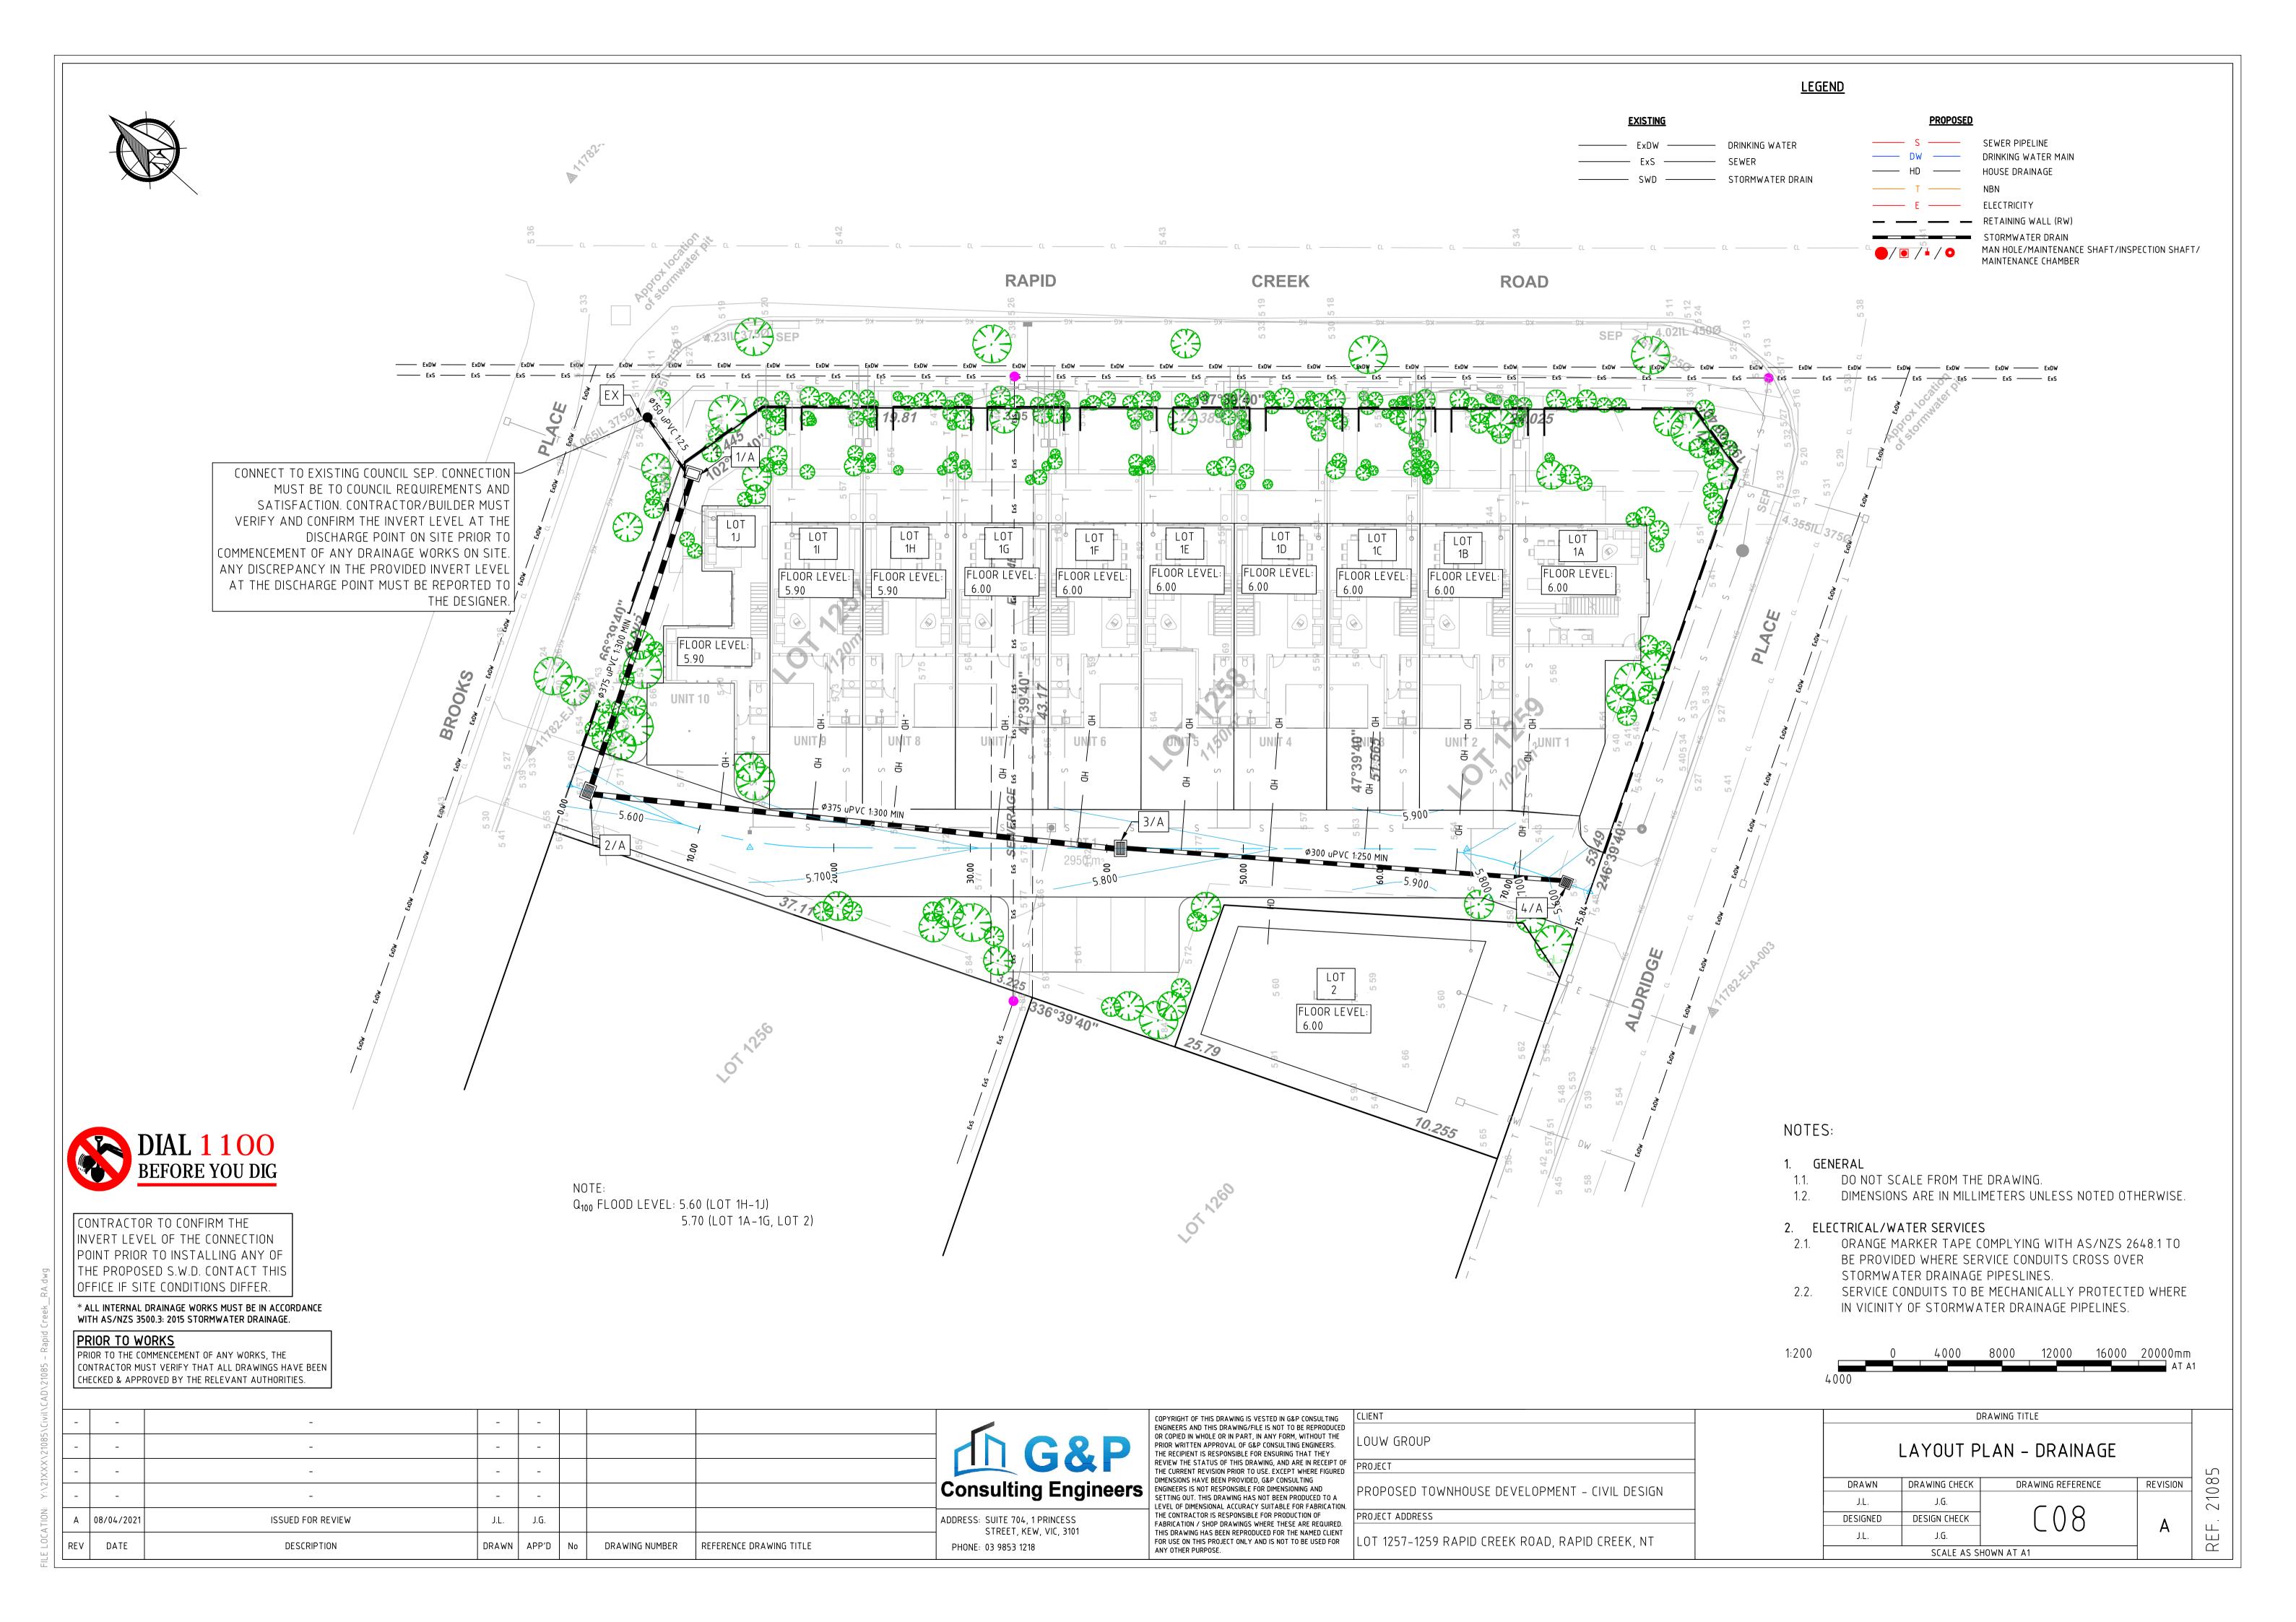

0	
3	
P.	
\triangleleft	
α	
~	
Ð	
L G	
P	
Di	
a	
α	
1	
085	
0	
21	
>	
\triangleleft	
Ų	
.≥	
:	
85	
8	
10	
/2	
~/	
\Diamond	
\sim	
$\widehat{}$	
2	
<u>/</u> :	
>-	
Ë	
\equiv	
✓	
0	
ш	
_	
正	L

\21XXX\21085\	-	-	-	-	-				G & Consulting Eng
<u>:</u>	-	-	-	-	-				
A LION	Α	08/04/2021	ISSUED FOR REVIEW	J.L.	J.G.				ADDRESS: SUITE 704, 1 PRINCESS STREET, KEW, VIC, 3101
LE LUC	REV	DATE	DESCRIPTION	DRAWN	APP'D	No	DRAWING NUMBER	REFERENCE DRAWING TITLE	PHONE: 03 9853 1218

COPYRIGHT OF THIS DRAWING IS VESTED IN G&P CONSULTING ENGINEERS AND THIS DRAWING/FILE IS NOT TO BE REPRODUCED OR COPIED IN WHOLE OR IN PART, IN ANY FORM, WITHOUT THE PRIOR WRITTEN APPROVAL OF G&P CONSULTING ENGINEERS. THE RECIPIENT IS RESPONSIBLE FOR ENSURING THAT THEY REVIEW THE STATUS OF THIS DRAWING, AND ARE IN RECEIPT OF THE CURRENT REVISION PRIOR TO USE. EXCEPT WHERE FIGURED DIMENSIONS HAVE BEEN PROVIDED, G&P CONSULTING ENGINEERS IS NOT RESPONSIBLE FOR DIMENSIONING AND SETTING OUT. THIS DRAWING HAS NOT BEEN PRODUCED TO A LEVEL OF DIMENSIONAL ACCURACY SUITABLE FOR FABRICATION. THE CONTRACTOR IS RESPONSIBLE FOR PRODUCTION OF FABRICATION / SHOP DRAWINGS WHERE THESE ARE REQUIRED. THIS DRAWING HAS BEEN REPRODUCED FOR THE NAMED CLIENT FOR USE ON THIS PROJECT ONLY AND IS NOT TO BE USED FOR ANY OTHER PURPOSE.

	CLIENT	
:D	LOUW GROUP	
OF D	PROJECT	
DN.	PROPOSED TOWNHOUSE DEVELOPMENT - CIVIL DESIGN	
1	PROJECT ADDRESS	
,. T	LOT 1257-1259 RAPID CREEK ROAD, RAPID CREEK, NT	

	WING TITLE	DR <i>A</i>	
	- LONGSECTION	DRAINAGE	
REVISION	DRAWING REFERENCE	DRAWING CHECK	DRAWN
	$C \cap C$	J.G.	J.L.
Λ	1 () 4	DESIGN CHECK	DESIGNED
· 🔼		J.G.	J.L.
A		I I	

DRAINAGE LONGITUNDINAL SECTION FOR LINE 1 SCALES: HORIZONTAL 1:250 VERTICAL 1:25

	/			1508 IL 4.221	00 IL 4.127 HL 4.074	
					€ 365	
PIPE DETAILS SLOPE/GRADE DATUM RL 1.4	150Ø PVC 1:2.5	375Ø PVC 1:300.3	▶◀	375Ø PVC 1:301.0	▶◀	300Ø PVC 1:250.0
DEPTH TO INVERT	2.850	0.982	0.998		1.018	0 661
INVERT LEVEL	2.405	4.458	695.7		4.729	068 7
FINISHED SURFACE	5.254	5.470	5.567		5.747	ጉ
EXISTING SURFACE	5.254	5.470	5.670		5.651	5 8 7 5 5 5 5 5 5 5 5 5 5 5 5 5 5 5 5 5
CHAINAGE	5.134	24.432	29.566	39.125	68.691	32.723

Pit Schedule – Drainage

Pit No.	Pił Type	Pit Width	Pit Length	Outlet Diameter	Outlet Invert RL	Inlet Diameter	Inlet Invert RL	Pit Depth	Pit Lid Level	Easting	Northing	Comment
		(mm)	(mm)	(mm)	(m)	(mm)	(m)	(m)	(m)	(m)	(m)	
EX	SEP	-	-			150	2.405	-	-	702797.25	8629760.109	EXISTING COUNCIL PIT
1/A	JP	600	900	150	4.458	375	4.488	1.012	5.47	702797.38	8629754.977	CLASS A COVER
1/B	GP	600	900	375	4.569	375	4.599	0.998	5.57	702775.13	8629744.869	CLASS C COVER
1/C	GP	600	900	375	4.729	300	4.759	1.018	5.75	702798.35	8629713.378	CLASS C COVER
1/D	GP	600	600	300	4.890			0.661	5.55	702818.48	8629687.576	CLASS C COVER

<u>NOTES</u>


1. GENERAL

1.1. DO NOT SCALE FROM THE DRAWINGS.

1.2. DIMENSIONS ARE IN MILLIMETERS U.N.O.

2. DRAINAGE

2.1. REFER SHEET 01 FOR DRAINAGE NOTES.

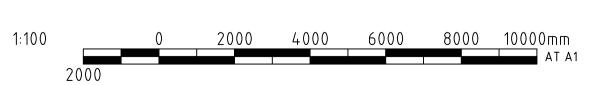



STREET, KEW, VIC, 3101

PHONE: 03 9853 1218

FOR USE ON THIS PROJECT ONLY AND IS NOT TO BE USED FOR

ANY OTHER PURPOSE.

LOT 1257-1259 RAPID CREEK ROAD, RAPID CREEK, NT

SCALE AS SHOWN AT A1


REV DATE

DESCRIPTION

DRAWN APP'D

DRAWING NUMBER

REFERENCE DRAWING TITLE

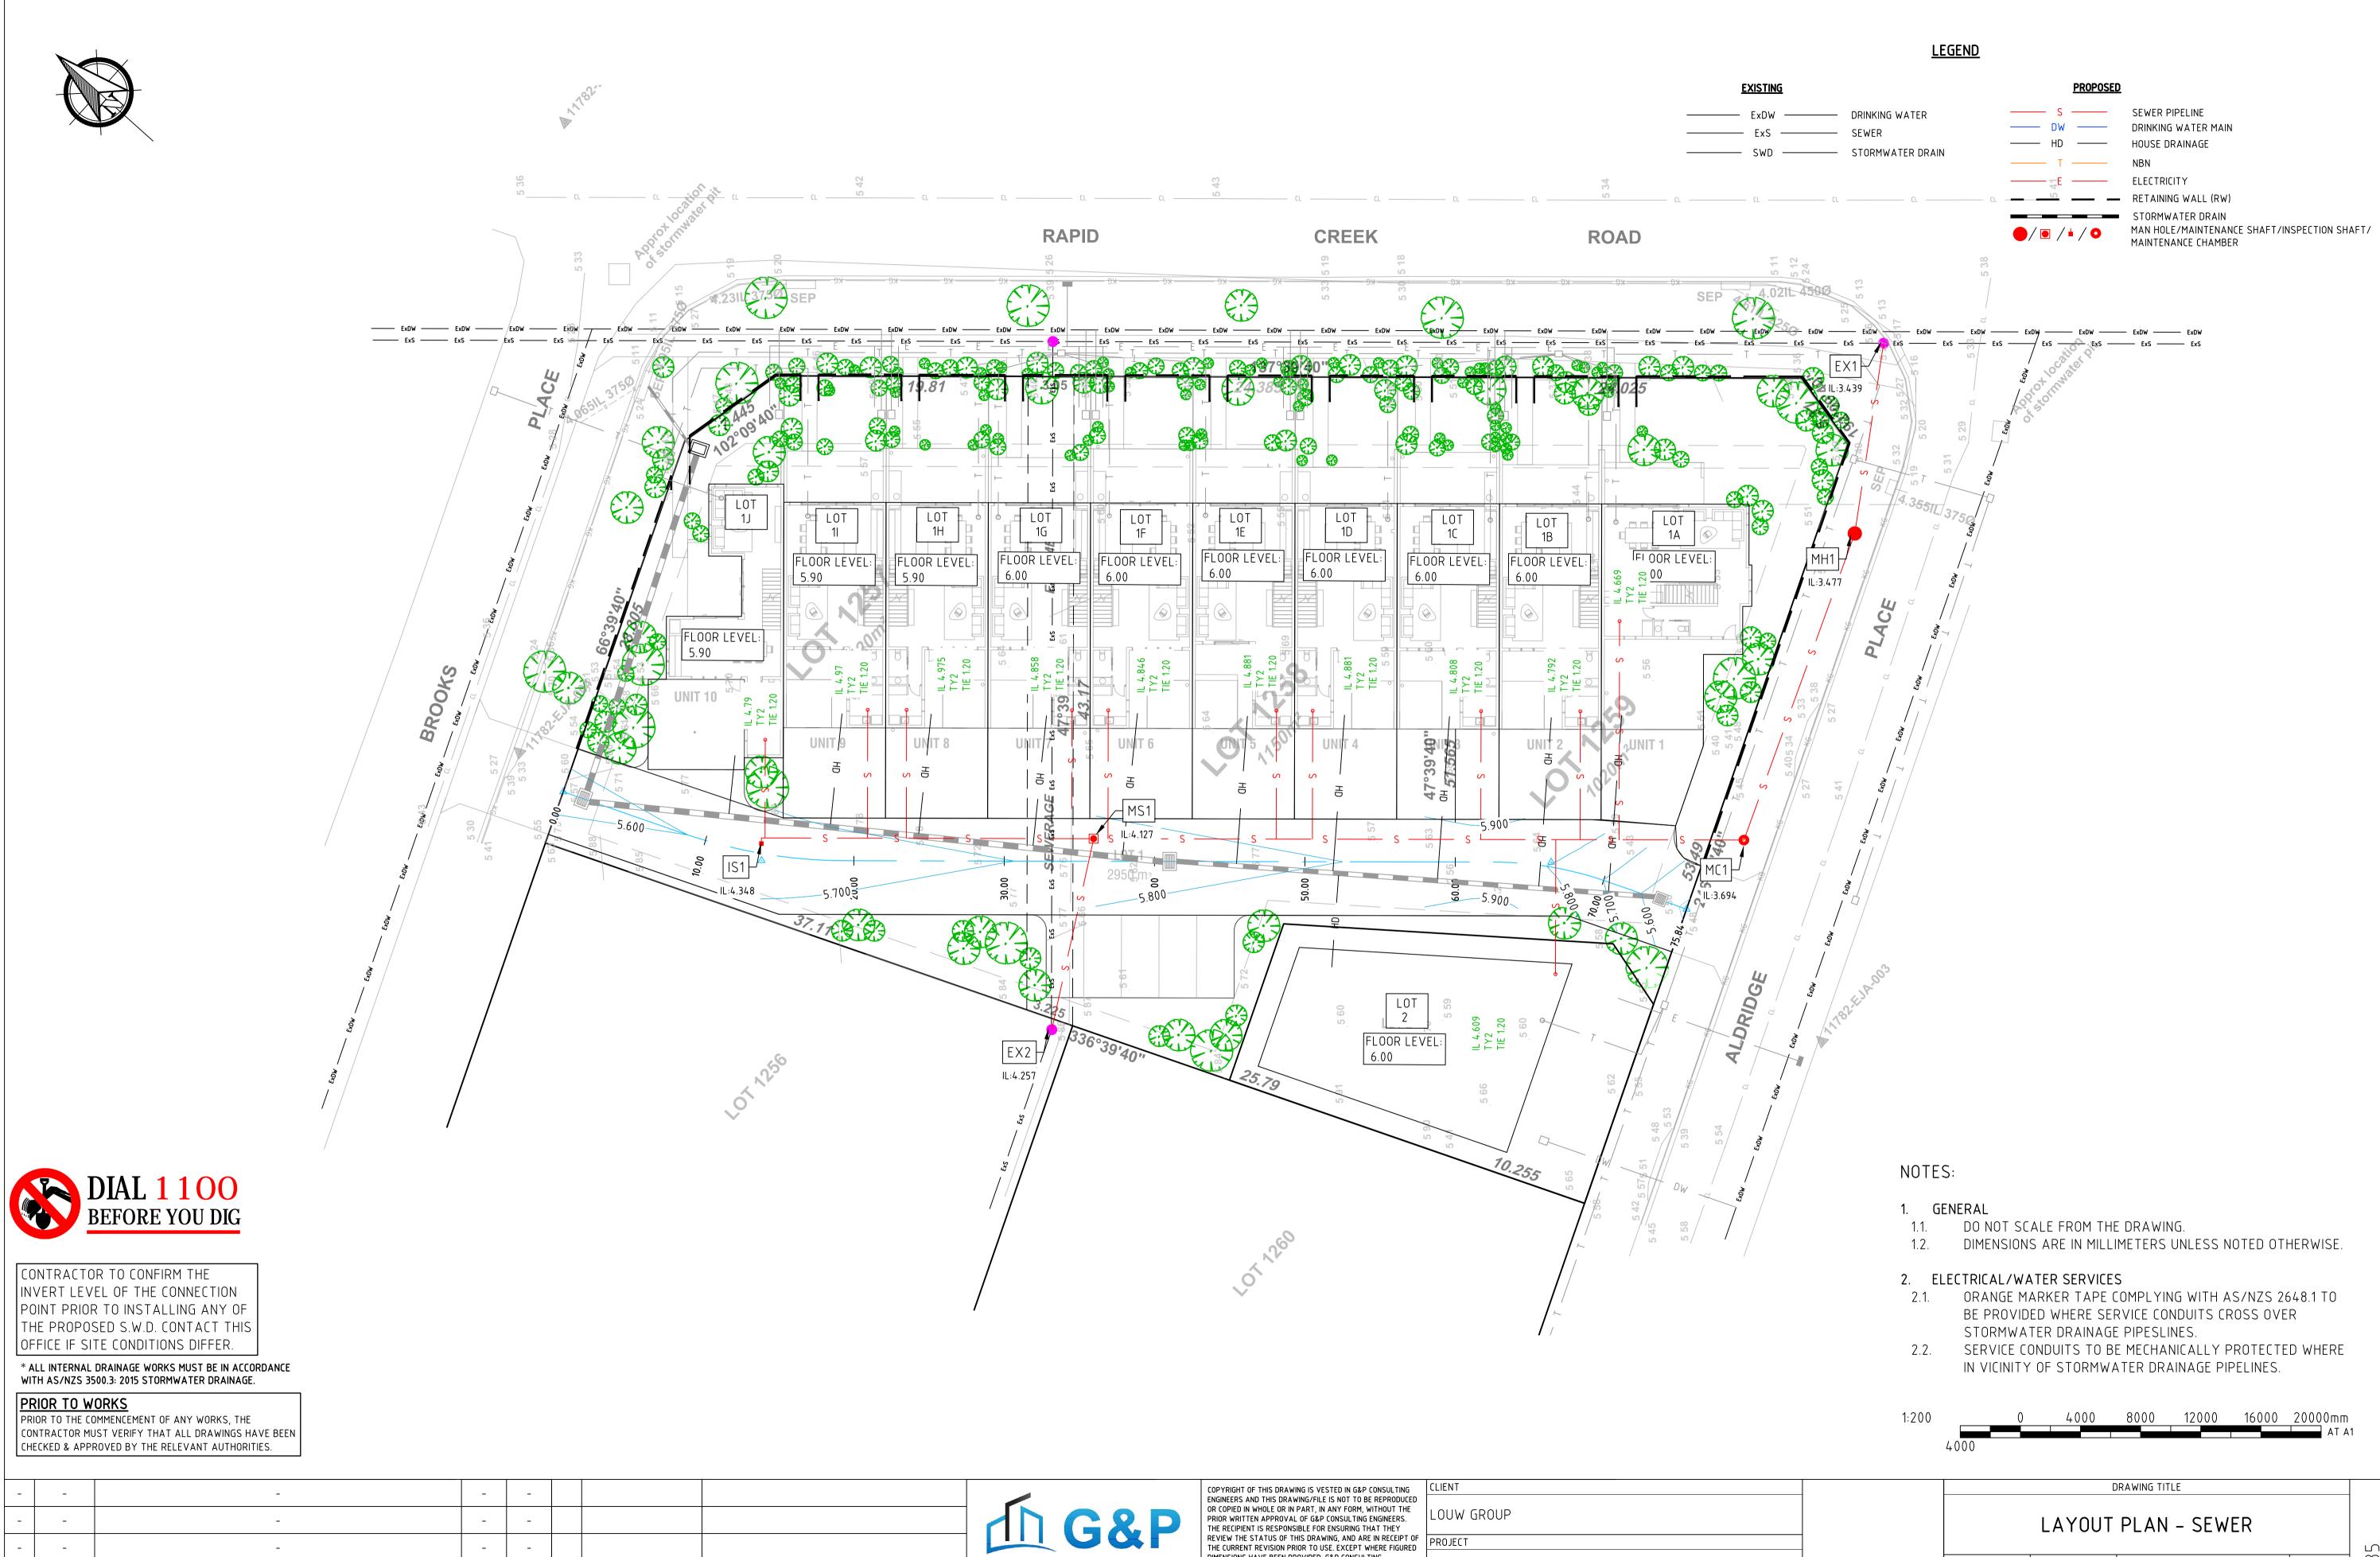

FILE LOCATION: Y:\21XXX\21085\Civil\CAD\21085 - Rapid Creek

- - - - - A 08/04/2021

ISSUED FOR REVIEW

DESCRIPTION

J.G.

DRAWING NUMBER

REFERENCE DRAWING TITLE

DRAWN APP'D

Consulting Engineers

ADDRESS: SUITE 704, 1 PRINCESS
STREET, KEW, VIC, 3101

PHONE: 03 9853 1218

OR COPIED IN WHOLE OR IN PART, IN ANY FORM, WITHOUT THE PRIOR WRITTEN APPROVAL OF G&P CONSULTING ENGINEERS. THE RECIPIENT IS RESPONSIBLE FOR ENSURING THAT THEY REVIEW THE STATUS OF THIS DRAWING, AND ARE IN RECEIPT OF THE CURRENT REVISION PRIOR TO USE. EXCEPT WHERE FIGURED DIMENSIONS HAVE BEEN PROVIDED, G&P CONSULTING ENGINEERS IS NOT RESPONSIBLE FOR DIMENSIONING AND SETTING OUT. THIS DRAWING HAS NOT BEEN PRODUCED TO A LEVEL OF DIMENSIONAL ACCURACY SUITABLE FOR FABRICATION. THE CONTRACTOR IS RESPONSIBLE FOR PRODUCTION OF FABRICATION / SHOP DRAWINGS WHERE THESE ARE REQUIRED. THIS DRAWING HAS BEEN REPRODUCED FOR THE NAMED CLIENT FOR USE ON THIS PROJECT ONLY AND IS NOT TO BE USED FOR ANY OTHER PURPOSE.

LOUW GROUP
PROJECT
PROPOSED TOWNHOUSE DEVELOPMENT - CIVIL DESIGN
PROJECT ADDRESS
LOT 1257–1259 RAPID CREEK ROAD, RAPID CREEK, NT

	D	PRAWING TITLE		
	LAYOUT	PLAN - SEWER		2
DRAWN	DRAWING CHECK	DRAWING REFERENCE	REVISION	08
J.L.	J.G.	CAA		21(
DESIGNED	DESIGN CHECK		Λ	
J.L.	J.G.		A	YEF
	SCALE AS SI	HOWN AT A1		

0.	
⋖	
r,	
_	
a)	
a l	
5	
<u>a</u>	
T	
I	
Q	
ΩΩ	
7	
-	
\supset	
L'A	
=	L
=	
5	
Q) \	Т
5	
7	
-	L
×	
\geq	
_	
7	Г
_	
	L
6	
\equiv	
abla	
$\overline{}$	Г
0	
Щ	L

-	-	- -	-	-		G&P Consulting Engineers
A	08/04/2021	ISSUED FOR REVIEW	J.L.	J.G.		ADDRESS: SUITE 704, 1 PRINCESS
REV	DATE	DESCRIPTION	DRAWN	APP'D No	DRAWING NUMBER REFERENCE DRAWING TITLE	STREET, KEW, VIC, 3101 PHONE: 03 9853 1218

PIPE DETAILS SLOPE/GRADE

DATUM RL 2.3

INVERT LEVEL

DEPTH TO INVERT

FINISHED SURFACE

EXISTING SURFACE

CHAINAGE

150Ø PVC 1:100.0

12.789

150Ø PVC 1:100.0

21.679

COPYRIGHT OF THIS DRAWING IS VESTED IN G&P CONSULTING ENGINEERS AND THIS DRAWING/FILE IS NOT TO BE REPRODUCED OR COPIED IN WHOLE OR IN PART, IN ANY FORM, WITHOUT THE PRIOR WRITTEN APPROVAL OF G&P CONSULTING ENGINEERS. THE RECIPIENT IS RESPONSIBLE FOR ENSURING THAT THEY REVIEW THE STATUS OF THIS DRAWING, AND ARE IN RECEIPT OF THE CURRENT REVISION PRIOR TO USE. EXCEPT WHERE FIGURED DIMENSIONS HAVE BEEN PROVIDED, G&P CONSULTING ENGINEERS IS NOT RESPONSIBLE FOR DIMENSIONING AND SETTING OUT. THIS DRAWING HAS NOT BEEN PRODUCED TO A LEVEL OF DIMENSIONAL ACCURACY SUITABLE FOR FABRICATION. THE CONTRACTOR IS RESPONSIBLE FOR PRODUCTION OF FABRICATION / SHOP DRAWINGS WHERE THESE ARE REQUIRED. THIS DRAWING HAS BEEN REPRODUCED FOR THE NAMED CLIENT FOR USE ON THIS PROJECT ONLY AND IS NOT TO BE USED FOR ANY OTHER PURPOSE.			
	S	ENGINEERS AND THIS DRAWING/FILE IS NOT TO BE REPRODUCED OR COPIED IN WHOLE OR IN PART, IN ANY FORM, WITHOUT THE PRIOR WRITTEN APPROVAL OF G&P CONSULTING ENGINEERS. THE RECIPIENT IS RESPONSIBLE FOR ENSURING THAT THEY REVIEW THE STATUS OF THIS DRAWING, AND ARE IN RECEIPT OF THE CURRENT REVISION PRIOR TO USE. EXCEPT WHERE FIGURED DIMENSIONS HAVE BEEN PROVIDED, G&P CONSULTING ENGINEERS IS NOT RESPONSIBLE FOR DIMENSIONING AND SETTING OUT. THIS DRAWING HAS NOT BEEN PRODUCED TO A LEVEL OF DIMENSIONAL ACCURACY SUITABLE FOR FABRICATION. THE CONTRACTOR IS RESPONSIBLE FOR PRODUCTION OF FABRICATION / SHOP DRAWINGS WHERE THESE ARE REQUIRED. THIS DRAWING HAS BEEN REPRODUCED FOR THE NAMED CLIENT FOR USE ON THIS PROJECT ONLY AND IS NOT TO BE USED FOR	P

43.253

SEWER LONGITUNDINAL SECTION FOR LINE 1

SCALES: HORIZONTAL 1:250 VERTICAL 1:25

CLIENT	
1 0111 / 6 0 0 1 0	
LOUW GROUP	
PRO IFCT	
T NOSECT	
PROPOSED TOWNHOUSE DEVELOPMENT - CIVIL DESIGN	
PROJECT ADDRESS	
I OT 1257, 1250 DADID CDEEK DOAD, DADID CDEEK NIT	
LUT 1257-1259 RAPID CREEK RUAD, RAPID CREEK, NT	
	LOUW GROUP PROJECT PROPOSED TOWNHOUSE DEVELOPMENT - CIVIL DESIGN

22.099

	DRA	AWING TITLE	
	SEWER -	LONGSECTION	
DRAWN	DRAWING CHECK	DRAWING REFERENCE	REVISION
J.L.	J.G.	CAO	
DESIGNED	DESIGN CHECK	(1)	Λ .
J.L.	J.G.		A
	SCALE AS SHO	\./NL A T. A 4	

<u>NOTES</u>

12.997

SEWER LONGITUNDINAL SECTION FOR LINE 2

SCALES: HORIZONTAL 1:250 VERTICAL 1:25


1. GENERAL


1.1. DO NOT SCALE FROM THE DRAWINGS.


1.2. DIMENSIONS ARE IN MILLIMETERS U.N.O.


2. DRAINAGE

2.1. REFER SHEET 01 FOR DRAINAGE NOTES.

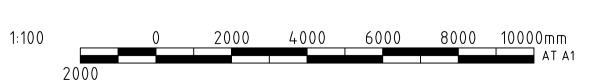

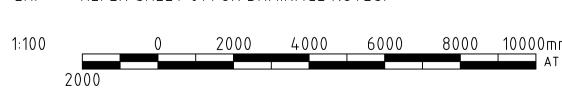

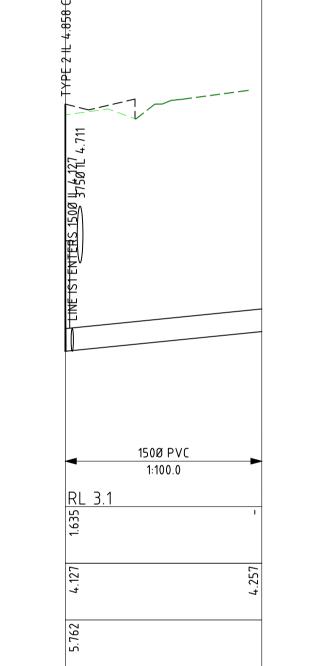

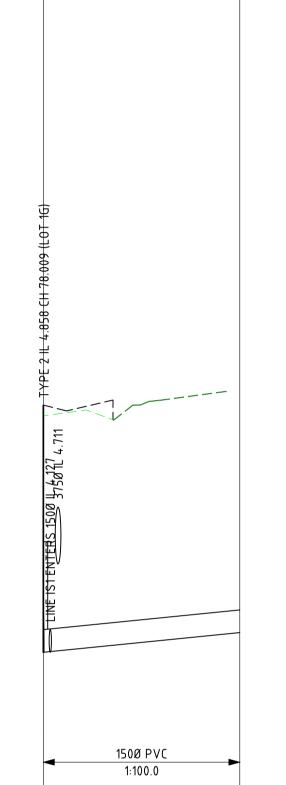



-	-	-	-	-				
-	-	-	-	-				
-	-	-	-	-				Cor
Α	08/04/2021	ISSUED FOR REVIEW	J.L.	J.G.				ADDRES
REV	DATE	DESCRIPTION	DRAWN	APP'D	No	DRAWING NUMBER	REFERENCE DRAWING TITLE	PHON

RESS: SUITE 704, 1 PRINCESS STREET, KEW, VIC, 3101 HONE: 03 9853 1218

PRIOR WRITTEN APPROVAL OF G&P CONSULTING ENGINEERS. THE RECIPIENT IS RESPONSIBLE FOR ENSURING THAT THEY REVIEW THE STATUS OF THIS DRAWING, AND ARE IN RECEIPT OF THE CURRENT REVISION PRIOR TO USE. EXCEPT WHERE FIGURED DIMENSIONS HAVE BEEN PROVIDED, G&P CONSULTING ENGINEERS IS NOT RESPONSIBLE FOR DIMENSIONING AND
SETTING OUT. THIS DRAWING HAS NOT BEEN PRODUCED TO A LEVEL OF DIMENSIONAL ACCURACY SUITABLE FOR FABRICATION. THE CONTRACTOR IS RESPONSIBLE FOR PRODUCTION OF FABRICATION / SHOP DRAWINGS WHERE THESE ARE REQUIRED.
THIS DRAWING HAS BEEN REPRODUCED FOR THE NAMED CLIENT FOR USE ON THIS PROJECT ONLY AND IS NOT TO BE USED FOR

LOUW GROUP
PROJECT
PROPOSED TOWNHOUSE DEVELOPMENT - CIVIL DESIGN
PROJECT ADDRESS
LOT 1257–1259 RAPID CREEK ROAD, RAPID CREEK, NT

CIVIL DETAILS - PIPE BACKFILL 21085 DRAWING REFERENCE DRAWN DRAWING CHECK REVISION J.G. J.L. DESIGNED DESIGN CHECK REF. J.G. SCALE AS SHOWN AT A1

RIGID PIPES - UNDER LANDSCAPED AREAS SCALE 1:10

OVERLAY ZONE

RIGID PIPES - UNDER ROADWAY

SCALE 1:10



COPYRIGHT OF THIS DRAWING IS VESTED IN G&P CONSULTING ENGINEERS AND THIS DRAWING/FILE IS NOT TO BE REPRODUCED OR COPIED IN WHOLE OR IN PART, IN ANY FORM, WITHOUT THE

LIENT
OUW GROUP
ROJECT
PROPOSED TOWNHOUSE DEVELOPMENT - CIVIL DESIGN
ROJECT ADDRESS
OT 1257 1250 DADID CDEEK DOAD DADID CDEEK NIT

1:10		0	200	400	600	800	1000mm
	200 100						AT A1



- 1.1. DO NOT SCALE FROM THE DRAWINGS.
- DIMENSIONS ARE IN MILLIMETERS U.N.O.

GENERAL

NOTES

TABLE 1 – MINIMUM COVER

TABLE 2 – RIGID PIPE BEDDING VALUES

TABLE 3 – FLEXIBLE PIPE BEDDING VALUES

100

150

75

100

100

150

150

150

VEHICULAR LOADING - SEALED/UNSEALED ROAD

0.1 D

0.3 D

D

100

150

150

150

200

300

MINIMUM COVER (mm)

300

450

500

LARGER OF D/6 OR 150

LARGER OF D/6 OR 150

100

150

200

300

350

0.25 D

2. PIPE BEDDING 2.1. ALL EMBEDMENT TO BE AS PER AS 3500.3, AS 3725 AND AS 2566.1



					·		
	1:10	0	200	400	600	800	<u>100</u> 0mm
		200 100					AT
1				DRAWING TIT			
				DIVA WING 111			

	NATURAL SURFACE
MINIMUM COVER OVERLAY ZONE	SELECT FILL: MATERIAL OBTAINED FROM EXCAVATION OF THE PIPE TRENCH OR ELSEWHERE WITH A PARTICLE SIZE NOT GREATER THAN 75mm, AND WHICH CONFORMS WITH THE SOIL CLASSES AS DEFINED IN AS 1726, TABLE 1. OVERLAY MATERIAL TO CONSIST OF SAND OR FCR
72	100 mm COMPACTED DEPTH APPROVED BEDDING MATERIAL
DIGID DIDEC LINDED LANDCCA	DED ADEAC

PROPOSED PAVEMENT.

CROSS SECTION DETAIL.

REFER TO ROADWAY TYPICAL

/ \rangle \rangle \rangle

- PAVEMENT SUBGRADE

20 mm NOM SIZE CLASS 3 FINE CRUSHED ROCK

COMPACTED TO 95% MODIFIED RELATIVE COMPACTION IN 150 mm THICK LAYERS.


- OVERLAY MATERIAL TO


CONSIST OF SAND OR FCR


APPROVED COMPACTED SAND OR FCR HAUNCH

100 mm COMPACTED DEPTH

APPROVED BEDDING MATERIAL

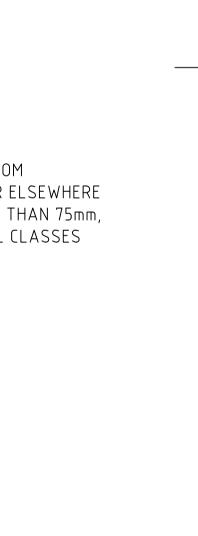

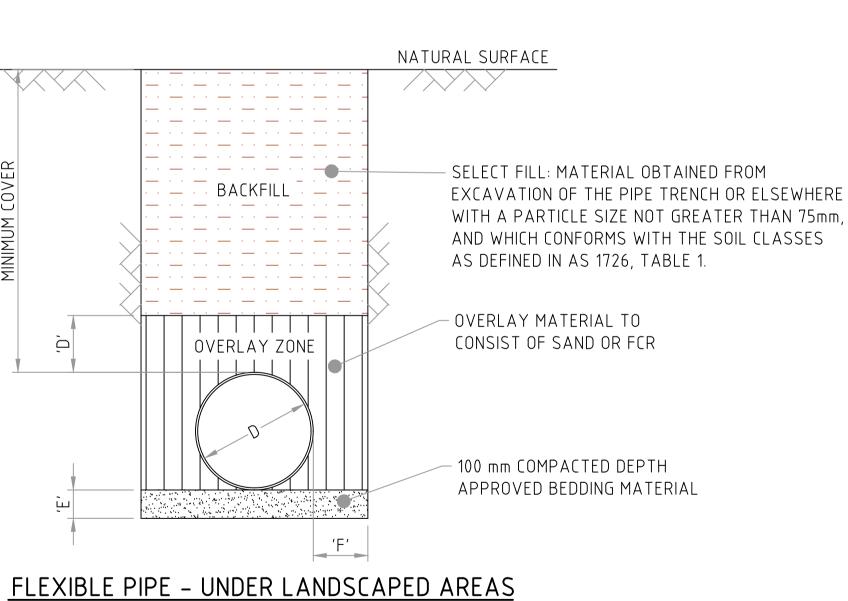

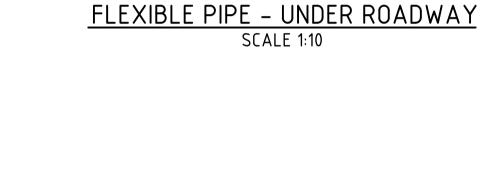

SCALE 1:10

 \rightarrow OVERLAY ZONE OVERLAY MATERIAL TO

COMPACTION IN 150 mm THICK LAYERS.

CONSIST OF SAND OR FCR

100 mm COMPACTED DEPTH

APPROVED BEDDING MATERIAL

TAVEITENT SOBUNADE	
— 20 mm NOM SIZE CLASS 3 FINE CRUSHED I	ROCK
COMPACTED TO 95% MODIFIED RELATIVE	

└ PAVEMENT SUBGRADE	

DAV/EMENIT	CLIDCDADE	

- PAVEMENT	SUBGRADE	

. · · · · △	LOCATION
	NO VEHICULAR LOADING
	VEHICULAR LOADING - NORMAL DUTY PAVEMENT

PIPE DIAMETER (mm)

 $D \le 1500$

D > 1500

PIPE DIAMETER (mm)

75 – 150

150 – 300

300 - 450


450 - 900


900 - 1500

1500 - 4000


PROPOSED PAVEMENT. REFER TO ROADWAY TYPICAL CROSS SECTION DETAIL.




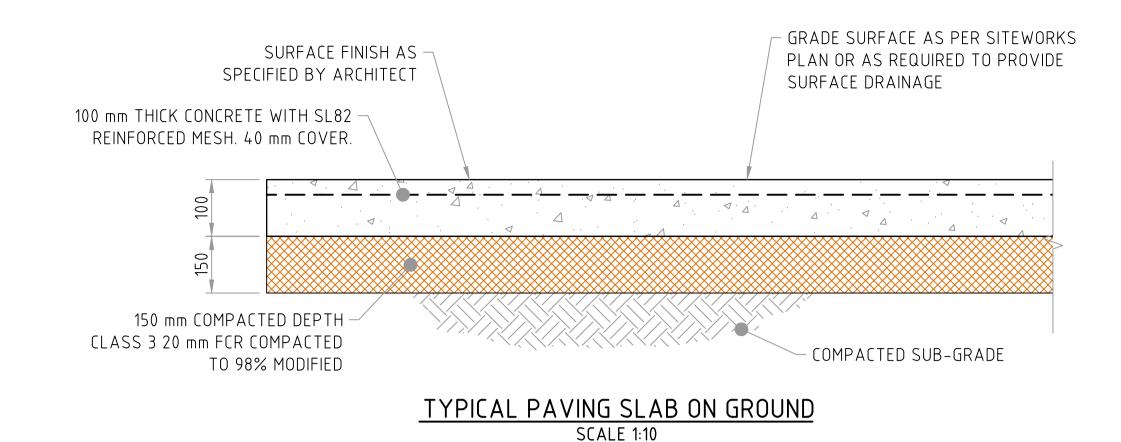

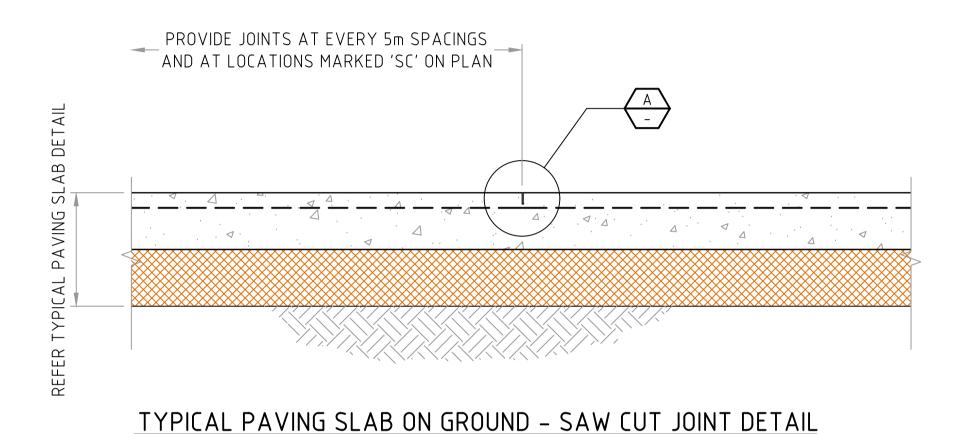


SCALE 1:10

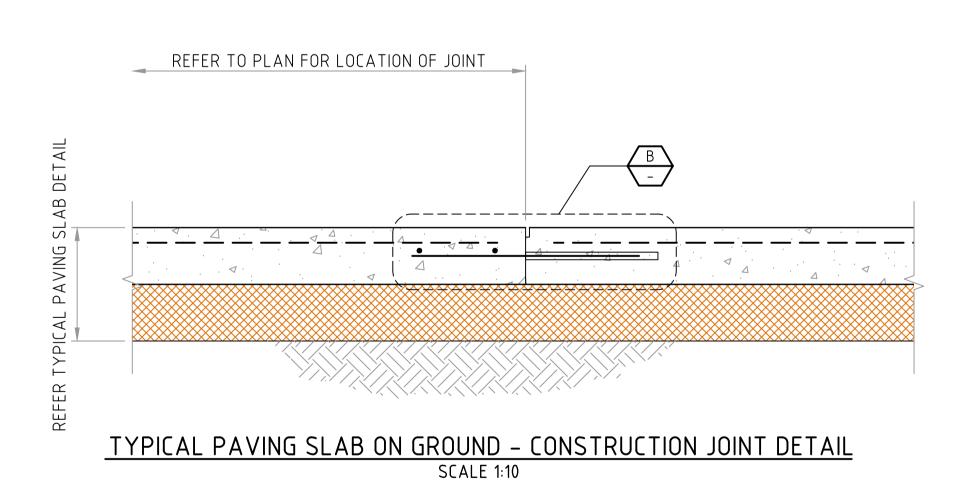

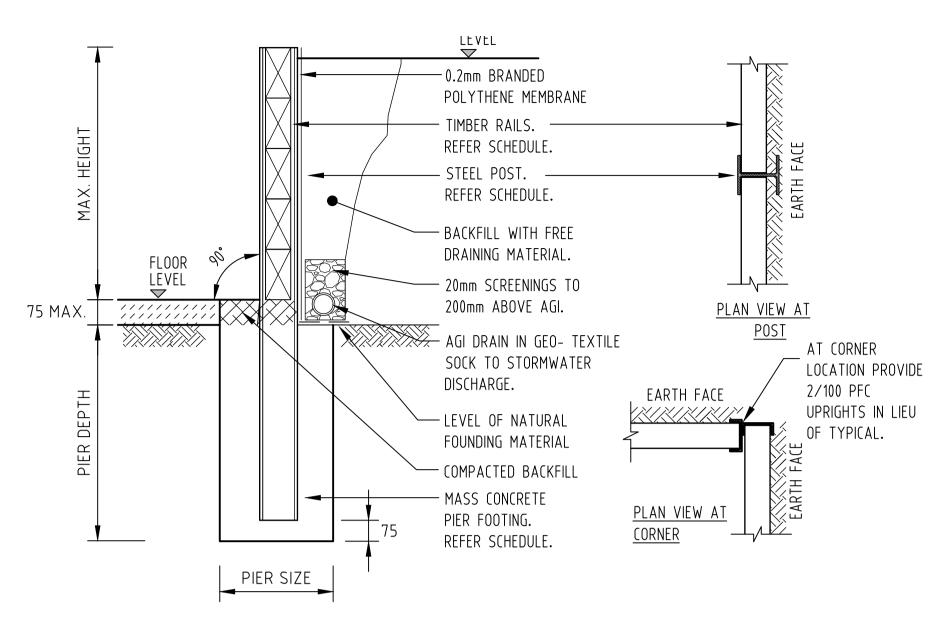


TYPICAL RW SLEEPER RETAINING WALL (STEEL POST) SCALE:1:20

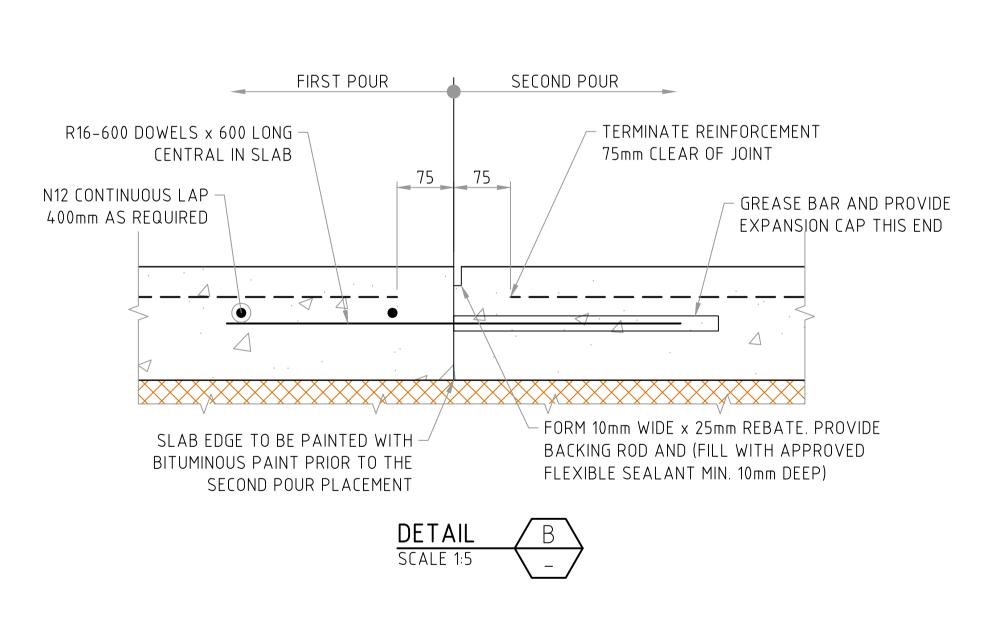

RETAINING WALL SCHEDULE (STEEL POST) – RAIL TO BE F7 TREATED PINE					
MAX. WALL HEIGHT	0 – 600mm.	600 - 1200mm	1200 - 1800mm		
POST SIZE	100UC14	100UC14	150UB14		
POST SPACING	2400mm	2400mm	1200mm		
RAIL SIZE	200 x 75	200 x 75	200 x 75		
PIER SIZE	Ø450	Ø450	Ø450		
PIFR DFPTH	1000mm	1800mm	1800mm		

- 1. ALL TIMBER RAILS ARE TO BE F7 TREATED PINE (TREATED TO H4 OR BETTER) WITH LIMITED UNTREATED HEARTWOOD - LIMIT 20%.
- 2. ALL STEEL POSTS ARE TO BE HOT DIP GALVANIZED.
- IF THE HEIGHT OF THE RETAINING WALL EXCEEDS THE HEIGHT NOTED, THIS OFFICE IS TO BE CONTACTED FOR FURTHER ADVICE.
- THIS RETAINING WALL HAS BEEN DESIGNED FOR A SURCHARGE OF 15kPa.
- THE PIER FOOTINGS HAVE BEEN DESIGNED FOR A MINIMUM BEARING PRESSURE OF 200
- FOOTINGS MUST BE FULLY FOUNDED INTO THE FIRM NATURAL SILTSTONE AS NOTED IN THE SOIL REPORT.

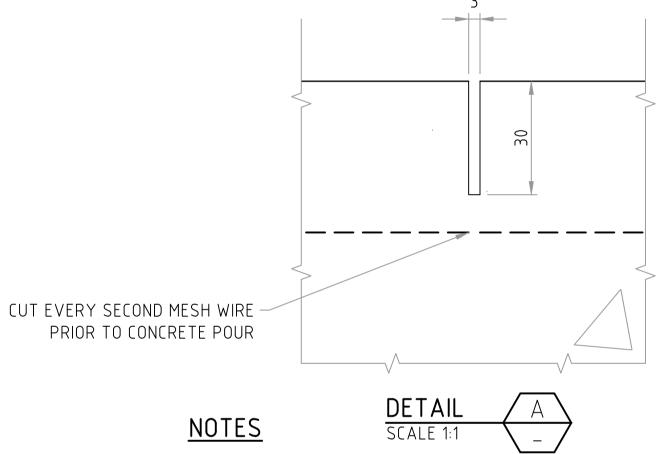

GENERAL

- 1.1. DO NOT SCALE FROM THE DRAWINGS.
- DIMENSIONS ARE IN MILLIMETERS U.N.O.

2. TYPICAL PAVING SLAB ON GROUND


- 2.1. REFER TO GEOTECHNICAL REPORT FOR SITE PREPARATION AND EARTHWORKS RECOMMENDATIONS.
- 3. TYPICAL PAVING SLAB ON GROUND SAW CUT JOINT DETAIL

3.1. DENOTED AS 'SC' ON PLAN

- 3.2. CUT EVERY SECOND MESH WIRE PRIOR TO CONCRETE POUR
- MARK LOCATION OF CUT MESH ON PAVEMENT SURFACE
- SAW CUT 30 MAX. DEPTH WITHIN 24 HOURS OF CONCRETE POUR
- SEAL JOINTS AS PER TYPICAL DETAIL

4. TYPICAL PAVING SLAB ON GROUND - CONSTRUCTION JOINT DETAIL

- DENOTED AS 'CJ' ON PLAN
- 4.2. DOWELS SHALL BE CORRECTLY ALIGNED AND SECURELY HELD PARALLEL TO THE SLAB SURFACE AND PERPENDICULAR TO THE LONGITUDINAL DIRECTION OF JOINT
- 4.3. DOWELS SHALL BE OMITTED WITHIN 900mm (HORIZONTALLY) OF A TRANSVERSE JOINT.

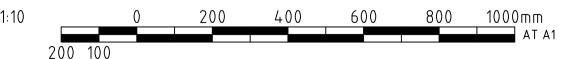

21085\Civil</th <th>-</th> <th>-</th> <th>-</th> <th>-</th> <th>-</th> <th></th> <th></th> <th></th> <th>Th G</th>	-	-	-	-	-				Th G
Y:\21XXX	-	-	-	-	-				Consulting
ATION:	Α	08/04/2021	ISSUED FOR REVIEW	J.L.	J.G.				ADDRESS: SUITE 704, 1 PRI STREET, KEW, V
707 E	REV	DATE	DESCRIPTION	DRAWN	APP'D	No	DRAWING NUMBER	REFERENCE DRAWING TITLE	PHONE: 03 9853 1218




STREET, KEW, VIC, 3101

COPYRIGHT OF THIS DRAWING IS VESTED IN G&P CONSULTING ENGINEERS AND THIS DRAWING/FILE IS NOT TO BE REPRODUCED OR COPIED IN WHOLE OR IN PART, IN ANY FORM, WITHOUT THE PRIOR WRITTEN APPROVAL OF G&P CONSULTING ENGINEERS. THE RECIPIENT IS RESPONSIBLE FOR ENSURING THAT THEY REVIEW THE STATUS OF THIS DRAWING, AND ARE IN RECEIPT O THE CURRENT REVISION PRIOR TO USE. EXCEPT WHERE FIGURE DIMENSIONS HAVE BEEN PROVIDED, G&P CONSULTING ENGINEERS IS NOT RESPONSIBLE FOR DIMENSIONING AND SETTING OUT. THIS DRAWING HAS NOT BEEN PRODUCED TO A LEVEL OF DIMENSIONAL ACCURACY SUITABLE FOR FABRICATION. THE CONTRACTOR IS RESPONSIBLE FOR PRODUCTION OF FABRICATION / SHOP DRAWINGS WHERE THESE ARE REQUIRED. THIS DRAWING HAS BEEN REPRODUCED FOR THE NAMED CLIENT FOR USE ON THIS PROJECT ONLY AND IS NOT TO BE USED FOR ANY OTHER PURPOSE.

	CLIENT	
ED :	LOUW GROUP	
OF D	PROJECT	
ON.	PROPOSED TOWNHOUSE DEVELOPMENT - CIVIL DESIGN	
1	PROJECT ADDRESS	
л. Т	LOT 1257-1259 RAPID CREEK ROAD, RAPID CREEK, NT	

200 100				
	D	RAWING TITLE		
CIVII	_ DETAILS	- PAVEMENT DETA	IL	5:
DRAWN	DRAWING CHECK	DRAWING REFERENCE	REVISION	08
J.L.	J.G.	CAI		21085
DESIGNED	DESIGN CHECK		Λ	
J.L.	J.G.		A	\ F F
	SCALE AS S	HOWN AT A1		

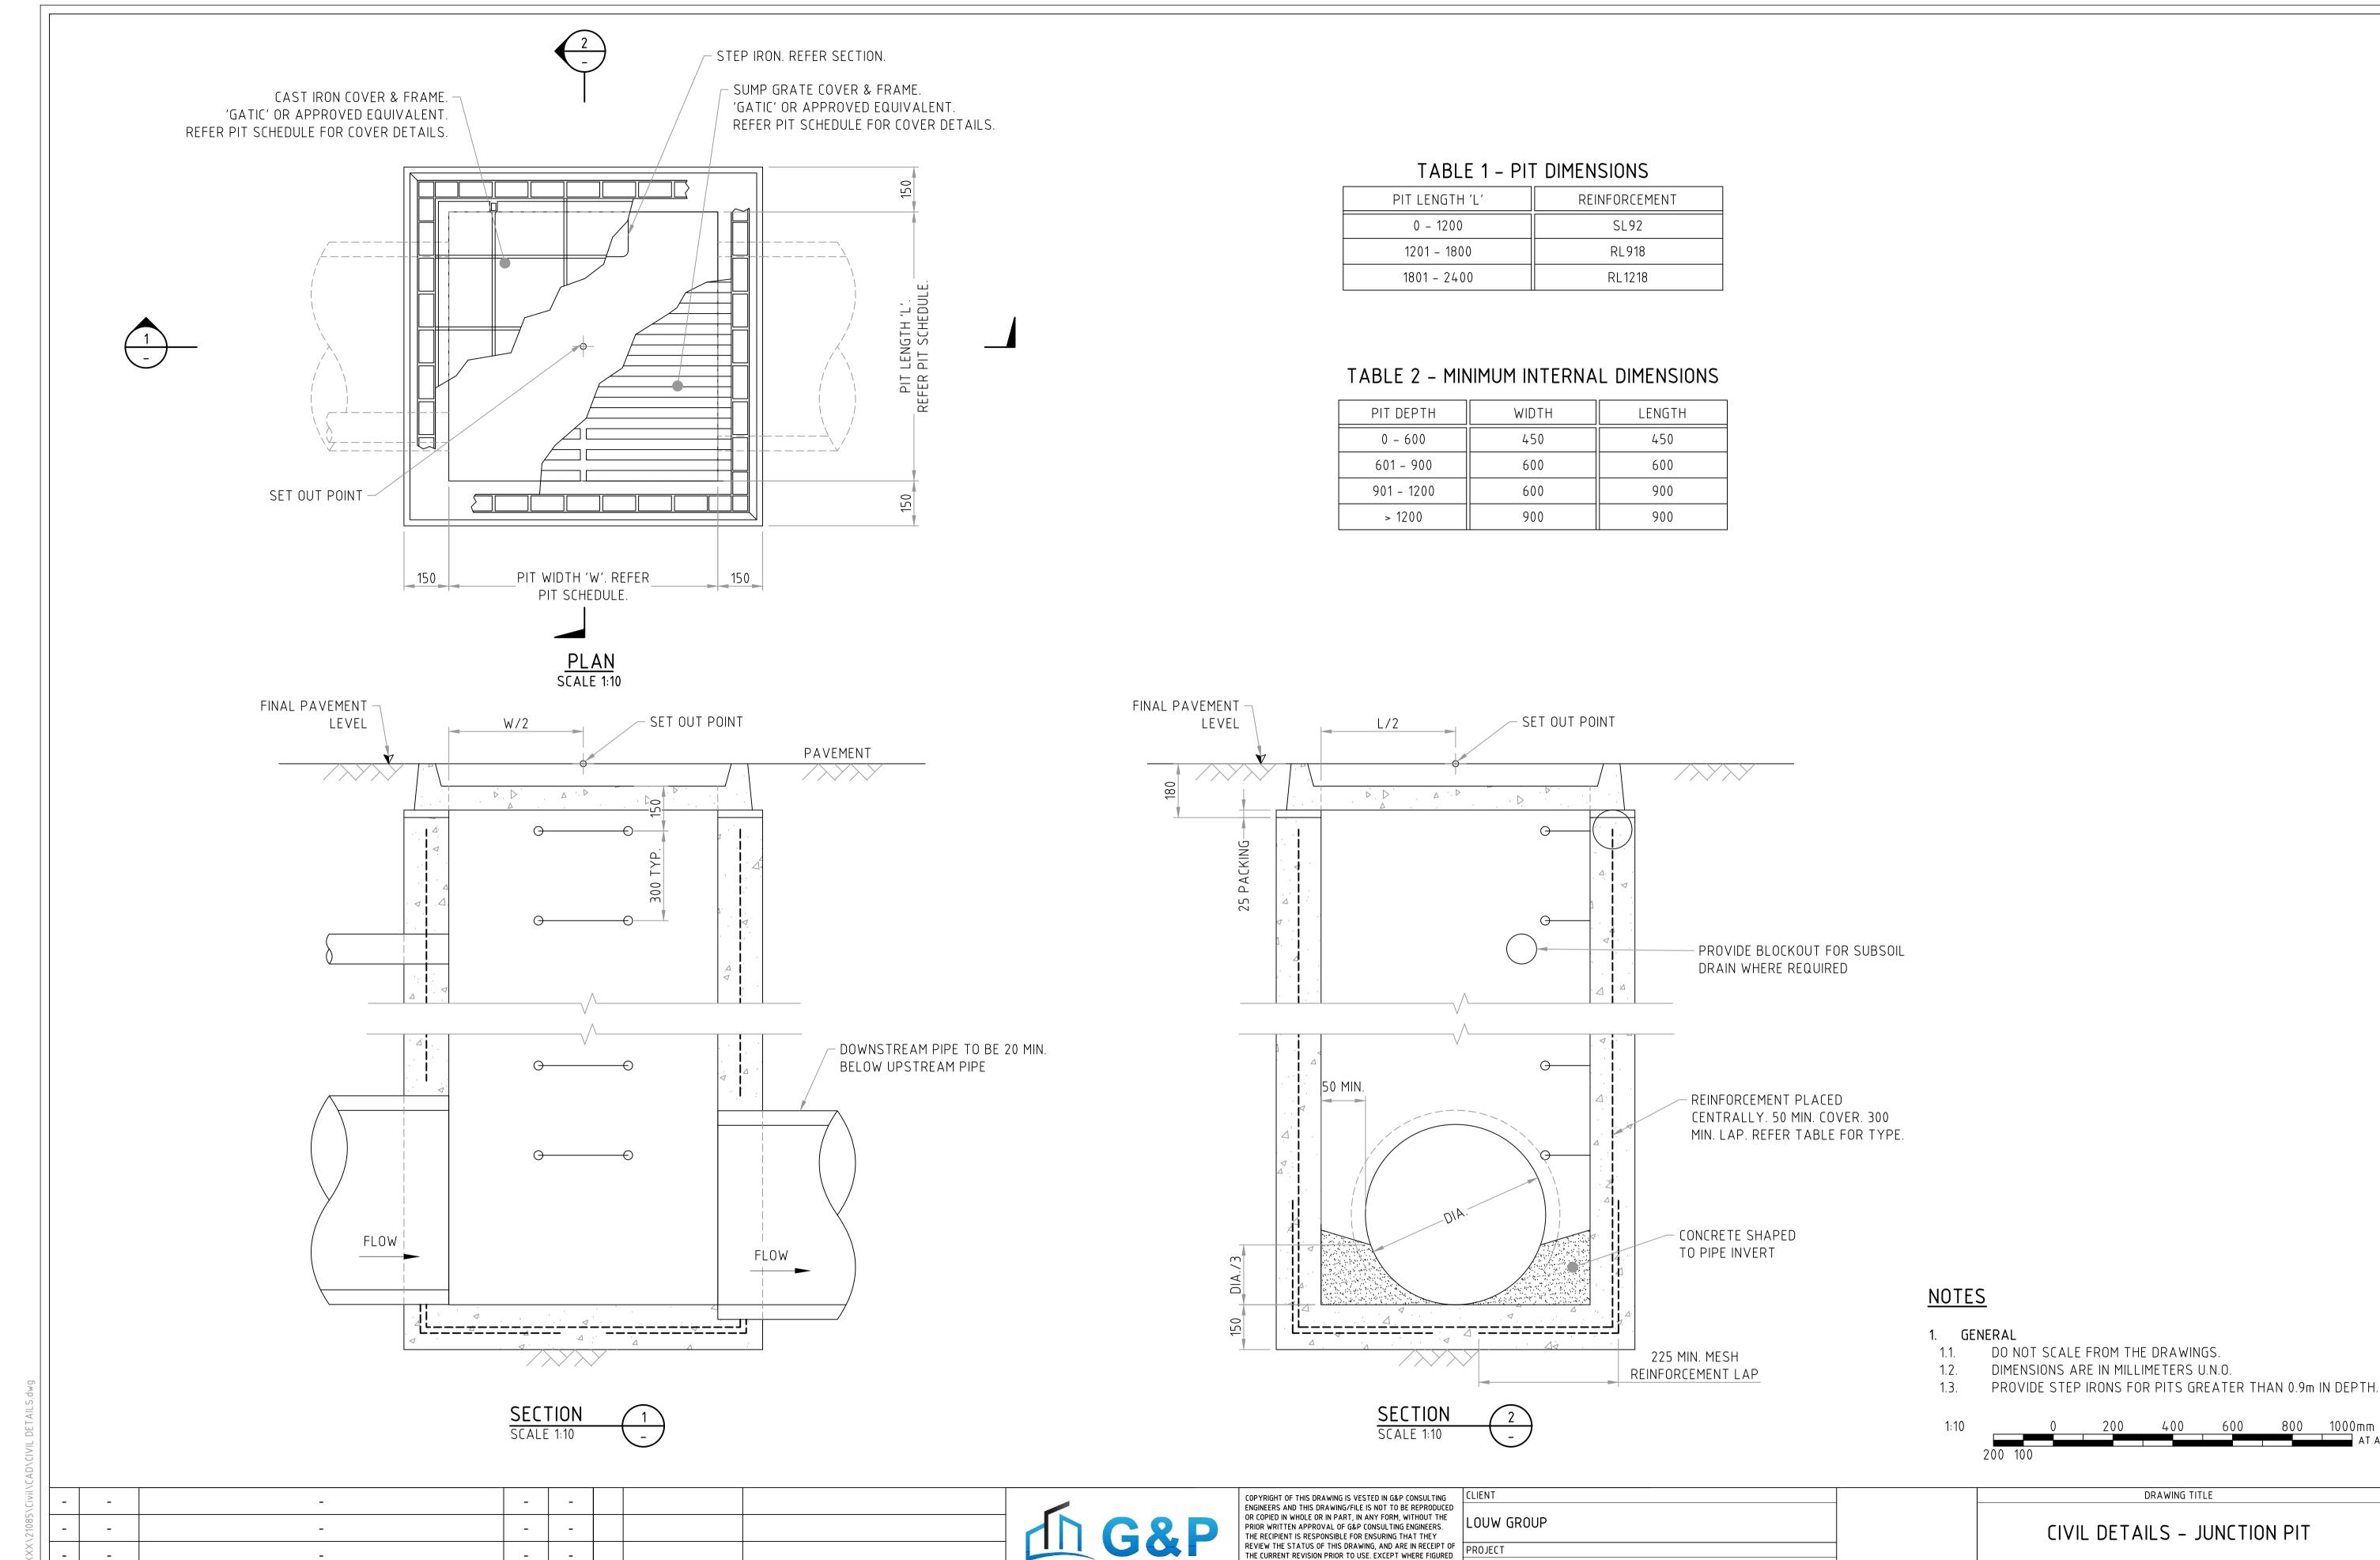

DIMENSIONS HAVE BEEN PROVIDED, G&P CONSULTING

ENGINEERS IS NOT RESPONSIBLE FOR DIMENSIONING AND SETTING OUT. THIS DRAWING HAS NOT BEEN PRODUCED TO A

LEVEL OF DIMENSIONAL ACCURACY SUITABLE FOR FABRICATION. THE CONTRACTOR IS RESPONSIBLE FOR PRODUCTION OF

FABRICATION / SHOP DRAWINGS WHERE THESE ARE REQUIRED.
THIS DRAWING HAS BEEN REPRODUCED FOR THE NAMED CLIENT

FOR USE ON THIS PROJECT ONLY AND IS NOT TO BE USED FOR

PROPOSED TOWNHOUSE DEVELOPMENT - CIVIL DESIGN

LOT 1257-1259 RAPID CREEK ROAD, RAPID CREEK, NT

Consulting Engineers

STREET, KEW, VIC, 3101

ADDRESS: SUITE 704, 1 PRINCESS

PHONE: 03 9853 1218

DRAWING TITLE

DRAWING REFERENCE

DRAWN

J.L.

DESIGNED

DRAWING CHECK

J.G.

DESIGN CHECK

J.G.

SCALE AS SHOWN AT A1

21085

REF.

REVISION

A 08/04/2021

REV DATE

ISSUED FOR REVIEW

DESCRIPTION

J.G.

DRAWING NUMBER

REFERENCE DRAWING TITLE

DRAWN APP'D