



SITE PLAN NOT TO SCALE

#### CCHEDITIE DE DDAMINGO

DRAWING No.	DRAWINGS (FOR INFORMATION ONLY)
21020-C140	EROSION AND SEDIMENT CONTROL COVER SHEET
21020-C141	EROSION AND SEDIMENT CONTROL NOTES
21020-C142	EROSION AND SEDIMENT CONTROLS LAYOUT PLAN (WET SEASON)
21020-C143	EROSION AND SEDIMENT CONTROLS FINISHES PLAN
DRAWING No.	STANDARD DRAWINGS
	IECA STANDARD DRAWINGS – DRAINAGE CONTROLS
DB-01	FLOW DIVERSION BANKS
RCD-01	CHECK DAMS
	IECA STANDARD DRAWINGS - EROSION CONTROLS
GRAVEL-01	GRAVELLING
R-01	REVEGETATION - GENERAL
	IECA STANDARD DRAWINGS - SEDIMENT CONTROLS
EXIT-01	CONSTRUCTION EXIT – ROCK PAD
EXIT-02	CONSTRUCTION EXIT - ROCK PAD (NOTES)
SF-01	SEDIMENT FENCE
SF-02	SEDIMENT FENCE (NOTES)
RFD-03	ROCK FILTER DAM
RFD-04	ROCK FILTER DAM (NOTES)
ESC-03	KERB INLET SEDIMENT TRAPS

 $REF.\ IECA\ STANDARD\ DRAWINGS\ -\ https://www.austieca.com.au/publications/book-6-standard-drawings$ 

	DEVELOR	PMENT PERMIT	TBC					
	CONSTRU	JCTION PERIOD	TBC					
	SUPERIN	TENDENT CONTACT	TBC	04XX XXX XXX				
CONTRACTOR CONTACTS								
	•	SITE MANAGER	TBC	04XX XXX XXX				
	•	PROJECT MANAGER	TBC	04XX XXX XXX				
	•	ENVIRONMENTAL OFFICER	TBC	04XX XXX XXX				
	•	ESCP DESIGNER	TBC	04XX XXX XXX				

#### GENERIC INSTALLATION SEQUENCE

THE FOLLOWING TABLE INDICATES MINIMUM EROSION AND SEDIMENT CONTROL MEASURES FOR THE WORKS. SITE CONDITIONS, SUCH AS THE PRESENCE OF DISPERSIVE SOILS, MAY WARRANT HIGHER EROSION AND SEDIMENT CONTROL STANDARDS. MARK OUT INITIAL LIMITS OF DISTURBANCE AND IDENTIFY LOCATION OF DISPERSIVE SOIL (IF ANY). IF DISPERSIVE SOIL IS ENCOUNTERED, CONTACT THE SUPERINTENDENT AND ESCP DESIGNER PRIOR TO COMMENCING WORKS.

ITEM	INSTALLED	REMOVED
ENTRY/EXIT ROCK PAD	PRIOR OR IN CONJUNCTION WITH SITE CLEARING.	ONCE SITE IS STABILISED AND ALL TEMPORARY FACILITIES HAVE BEEN REMOVED.
CLEAN WATER DIVERSION CHANNELS/BERMS	PRIOR OR IN CONJUNCTION WITH SITE CLEARING.	ONCE SITE IS STABILISED AND ALL TEMPORARY FACILITIES HAVE BEEN REMOVED.
ROCK FILTER DAMS	PRIOR OR IN CONJUNCTION WITH SITE CLEARING	ONCE SITE IS STABILISED AND ALL TEMPORARY FACILITIES HAVE BEEN REMOVED.
SEDIMENT FENCE	PRIOR OR IN CONJUNCTION WITH SITE CLEARING.	ONCE SITE IS STABILISED AND ALL TEMPORARY FACILITIES HAVE BEEN REMOVED.
GRAVELLING OF TEMP FACILITIES	UPON ESTABLISHMENT OF SITE ACCESS/EGRESS TRACK, SITE OFFICES AND CONTRACTOR CARPARK / LAYDOWN AREA.	ONCE WORKS ARE COMPLETE AND TEMPORARY FACILITIES HAVE BEEN DECOMMISSIONED.
ROCK CHECK DAMS	INSTALLED IN DRAINS IMMEDIATELY AFTER DRAIN CONSTRUCTION	REMOVED ONCE DRAINS ARE DECOMMISSIONED
FIELD AND KERB INLET SEDIMENT TRAPS	INSTALLED UPON COMPLETION OF STORMWATER PITS (GIPS, LBPS AND SEPS)	ONCE SITE IS STABILISED AND ALL TEMPORARY FACILITIES HAVE BEEN REMOVED.
REVEGETATION	IMMEDIATELY FOLLOWING COMPLETION OF WORKS	N/A

#### STAGING OF WORKS

ITEM OF WORKS	TIMING SCHEDULE		
1. SITE MOBILISATION AND ESTABLISHMENT	TBC		
2. ACCESS / ENTRY AND EXIT CONTROLS	TBC		
3. EARTHWORKS	TBC		
4. ROADWORKS	ТВС		
5. STORMWATER AND DRAINAGE	ТВС		
6. ELECTRICAL	ТВС		
7. LANDSCAPING AND REHABILITATION	PROGRESSIVE		

### EROSION RISK ASSESSMENT (LOT A)

CATCHMENT	AREA (ha)	R	К	LS	Р	С	A (t/ha/month)	A (t/month)	CONTROL
BULK EARTHWORKS (MAY TO SEP)	1.56	160	0.040	1.50	1.3	1.0	12.5	19.5	TYPE 1
BULK EARTHWORKS (MAY TO SEP) – STAGED	1.00	160	0.040	1.50	1.3	1.0	12.5	12.5	TYPE 2
ROAD WORKS / LOTS STABILISED (OCT - NOV)	1.56	948	0.040	0.34	1.3	0.34	5.7	8.9	TYPE 3
ROAD PAVEMENT UNDERWAY / COMPLETE (JAN – WORST CASE)	1.56	4496	0.040	0.17	1.3	0.14	6.0	9.0	TYPE 3

#### WARNING

#### BEWARE OF UNDERGROUND SERVICES

The locations of underground services are approximate only and their exact position should be proven on site No guarantee is given that all existing services are shown



BB

## BAYVIEW SUBDIVISION LOT A & B **EROSION & SEDIMENT CONTROL**

22007

AS SHOWN

#### 1. THIS IS A 'WET SEASON' ESCP FOR A SITE IN THE 'TOP END' OF THE NORTHERN TERRITORY

**GENERAL NOTES** 

- 2. ALL WORKS MUST BE UNDERTAKEN IN ACCORDANCE WITH THE APPROVED ESCP AND ASSOCIATED DEVELOPMENT CONDITIONS. 3. EROSION AND SEDIMENT CONTROL MEASURES MUST CONFORM TO
- THE STANDARDS AND SPECIFICATIONS CONTAINED IN:
- A.THE APPROVED ESCP AND SUPPORTING DOCUMENTATION; AND
- B. THE LATEST VERSION OF INTERNATIONAL EROSION CONTROL ASSOCIATION (IECA) GUIDELINES, IF THE STANDARDS AND SPECIFICATIONS ARE NOT CONTAINED IN THE APPROVED ESCP.
- 4. CONTRACTOR IS RESPONSIBLE FOR IMPLEMENTATION, MONITORING AND MANAGEMENT OF ALL EROSION AND SEDIMENT CONTROL MEASURES TO THE SATISFACTION OF DEPWS
- 5. CONTRACTOR MUST TAKE ALL REASONABLE AND PRACTICABLE MEASURES TO CONTROL STORM WATER FLOW VELOCITIES; MINIMISE SOIL EROSION AND SEDIMENT RUNOFF, AND MITIGATE ENVIRONMENTAL HARM.
- 6. UNEXPECTED CIRCUMSTANCES OR LARGE STORM EVENTS MAY NECESSITATE AMENDMENT OF THE ESCP. IN THE EVENT THAT SITE CONDITIONS CHANGE SIGNIFICANTLY FROM THOSE CONSIDERED WITHIN THE APPROVED ESCP, A REVISED EROSION AND SEDIMENT CONTROL PLAN (ESCP) MUST BE SUBMITTED FOR APPROVAL TO DEPWS AND ADDITIONAL EROSION AND SEDIMENT CONTROL MEASURES MUST BE IMPLEMENTED.
- 7. WHERE THERE IS HIGH PROBABILITY OF ENVIRONMENTAL HARM OCCURRING DUE TO SEDIMENT LEAVING THE SITE, CONTRACTOR MUST IMPLEMENT ALL REASONABLE AND PRACTICABLE MEASURES REQUIRED TO MITIGATE SUCH HARM, INCLUDING IMPLEMENTATION OF APPROPRIATE ADDITIONAL CONTROL MEASURES. WITH THE ESCP AMENDED AS SOON AS POSSIBLE, AND RE-SUBMITTED FOR APPROVAL TO DEPWS.
- 8. CONTRACTOR MUST MAINTAIN SUFFICIENT EROSION AND SEDIMENT CONTROL MATERIALS ON SITE FOR SHORT NOTICE REPAIRS.
- 9. CONTRACTOR MUST MONITOR THE WORKS AREA WEEKLY, OR DAILY DURING RAINFALL, AND ADAPT ESC PRACTICES AS REQUIRED TO MAINTAIN THE REQUIRED PERFORMANCE STANDARD.

#### **ERA NOTES**

- 1. GREATEST RAINFALL AT THE SITE IS TYPICALLY EXPERIENCED IN JANUARY. R-VALUES ADOPTED FOR THE BULK EARTHWORKS PHASE ARE THE REPORTED MAY VALUES FOR DARWIN AIRPORT.
- 2. BULK EARTHWORKS WILL NEED TO BE STAGED IN AREAS OF LESS THAN 1 HECTARE TO AVOID TRIGGERING A SEDIMENT BASIN, AS LS FACTORS ARE HIGH DUE TO EXISTING STEEP TERRAIN. ONCE THESE STEEP AREAS HAVE BEEN LEVELLED, THE ENTIRE SITE CAN BE WORKED.
- 3. K-VALUE WAS SELECTED BASED ON THE ASSUMPTION THAT SOIL WILL MOSTLY BE COMPRISED OF SILTY CLAY LOAM (SICL). THIS SOIL TYPE IS FAIRLY TYPICAL FOR MANGROVE AREAS. REFER TO IECA BEST PRACTICE GUIDELINES TABLE E4.

В

SK005

4. LS FACTORS WERE SELECTED ON THE FOLLOWING BASIS: BULK EARTHWORKS - 20% GRADE, 10m SLOPE LENGTH EARLY ROAD WORKS - 3% GRADE, 20m SLOPE LENGTH PAVEMENT WORKS - 3% GRADE, 5m SLOPE LENGTH

#### SITE MANAGEMENT

- CONSTRUCTION ACTIVITIES MUST BE STAGED SO THAT LAND DISTURBANCE IS CONFINED TO AREAS OF
  MANAGEABLE SIZE AND THE EXTENT AND DURATION OF SOIL EXPOSURE IS LIMITED. EROSION AND SEDIMENT
  CONTROL MEASURES MUST BE PROGRESSIVELY IMPLEMENTED TO SUIT.
- 2. ALL OFFICE AND OPERATIONAL ACTIVITIES MUST BE LOCATED SUCH THAT ALL LIQUID EFFLUENT (E.G. WASH-DOWN WATER) IS TOTALLY CONTAINED AND TREATED WITHIN THE SITE.
- 3. ALL LIQUIDS AND CHEMICALS MUST BE STORED AND HANDLED ON-SITE IN ACCORDANCE WITH RELEVANT
  STANDARDS, INCLUDING AS1940 THE STORAGE AND HANDLING OF FLAMMABLE AND COMBUSTIBLE LIQUIDS.
- 4. SITE SPOILS MUST BE LAWFULLY DISPOSED OF IN A MANNER THAT DOES NOT RESULT IN ONGOING SOIL EROSION OR ENVIRONMENTAL HARM.
- 5. EXCAVATION WORKS MUST BE STAGED SO THAT THE DURATION OF EXPOSED OPEN TRENCHES IS LIMITED.
  TRENCHING MUST ONLY BE OPENED UP WHERE IT IS INTENDED TO BE BACKFILLED IN THE SAME WORKING DAY
- 6. NO LIQUID EFFLUENT IS PERMITTED TO BE DISPOSED OF ON SITE.
- 7. ACCESS TRACKS ARE TO BE GRADED TO A CROWN OR WITH CROSSFALL DRAINAGE.
- 8. ACCESS TRACKS ARE TO INCORPORATE STABILISED EXIT POINTS.
- ACCESS TRACKS ARE TO BE MONITORED FOR EXCESSIVE SEDIMENT TRACKING INTO ADJACENT PUBLIC ROADS. A
  REVIEW OF THE CONTROLS WILL BE UNDERTAKEN AND ADDITIONAL MEASURES MAY BE EMPLOYED WHERE
  SEDIMENT BUILD-UP OCCURS ON PUBLIC ROADS AT VEHICLE EXIT POINTS.

#### CLEARING AND GRUBBING

- MINIMISE DISTURBANCE TO ONLY THOSE AREAS REQUIRED FOR CONSTRUCTION. ALL OTHER AREAS WILL BE FLAGGED AS "NO-GO ZONE"
- ALL CLEARING MUST BE CONDUCTED IN ACCORDANCE WITH FEDERAL, TERRITORY AND LOCAL GOVERNMENT ENVIRONMENTAL POLICIES.
- 3. BEFORE CLEARING COMMENCES, AREAS OF VEGETATION NOMINATED FOR PROTECTION MUST BE CLEARLY IDENTIFIED AND MARKED ON SITE (BY FLAGGING OR FENCING) AND INSPECTED BY THE SUPERINTENDENT. CLEARING OF VEGETATION MUST BE RESTRICTED TO THE NOMINATED AREAS. CONTRACTOR MUST TAKE ALL REASONABLE AND PRACTICABLE MEASURES TO MITIGATE RISK OF UNNECESSARY LAND CLEARING AND PREVENT REMOVAL OR DISTURBANCE OF ALL VEGETATION AND GROUND COVERS (ORGANIC OR INORGANIC) INTENDED TO BE RETAINED.
- 4. WHERE CLEARING IS REQUIRED FOR THE PURPOSE OF INSTALLING EROSION AND SEDIMENT CONTROL MEASURES, EXTENTS OF CLEARING MUST BE KEPT TO A MINIMUM.
- 5. DISTURBANCE OF THE NATURAL ENVIRONMENT MUST BE LIMITED TO THE MINIMUM IN KEEPING WITH THE SITE CLEARING PLANS.
- 6. CONTRACTOR MUST TAKE ALL PRACTICABLE AND REASONABLE MEASURES DURING CLEARING OPERATIONS TO PREVENT THE FORMATION OF FLOW PATHS THAT CAN CONCENTRATE SURFACE RUNOFF AND CREATE POTENTIAL FOR EROSION.

#### TOPSOIL AND STOCKPILE MANAGEMENT

- 1. SITE OF STOCKPILES, INCLUDING EXTENT AND LIMIT OF CLEARING, TO BE AGREED WITH SUPERINTENDENT.
- 2. STRIPPED TOPSOIL MUST BE STOCKPILED FOR REUSE. TOPSOIL STOCKPILE HEIGHTS MUST BE 1.5m MAX. ALL OTHER STOCKPILE HEIGHTS MUST BE 3.0m MAX WITH 1 IN 4 BATTERS MAX.
- 3. TOPSOIL STOCKPILE MUST NOT BE COMPACTED OR WHEEL ROLLED.
- 4. AVOID PLACEMENT OF STOCKPILES (WHERE PRACTICABLE) WITHIN 50m OF ANY DRAINS, DRAINAGE LINE OR OTHER WATERWAYS. SUITABLE TYPE 2/3 EROSION AND SEDIMENTATION CONTROLS TO BE IMPLEMENTED WHERE NOT
- 5. THE FOLLOWING CONTROLS MUST BE IMPLEMENTED FOR STOCKPILES OF ERODIBLE MATERIAL:
  - A.STOCKPILES MUST BE LOCATED AT LEAST 2m FROM ANY RETAINED VEGETATION AND CONCENTRATED DRAINAGE LINES.
- B.EARTH DIVERSION BUNDS MUST BE INSTALLED IMMEDIATELY UP-SLOPE OF THE STOCKPILE, WHERE THE CONTRIBUTING CATCHMENT EXCEEDS 1500m2 AND MUST BE MANAGED TO AVOID CONCENTRATING FLOW CAUSING EROSION.
- C.SEDIMENT CONTROL MEASURES MUST BE INSTALLED DOWNSTREAM OF THE STOCKPILE (E.G. MULCH BERMS OR SEDIMENT FENCES).
- D.TRENCH SPOIL AND BACKFILL MATERIAL MUST GENERALLY BE STOCKPILED A MINIMUM OF 1.0m FROM OPEN TRENCHES
- 6. STOCKPILE OF MATERIALS VULNERABLE TO SEDIMENTATION TO BE COVERED IF REQUIRED.
- 7. LONG-TERM STOCKPILES (10 DAYS OR MORE) MUST BE ADEQUATELY STABILISED (E.G. COVER, VEGETATION, SOIL BINDER, OR OTHER) AS DEEMED APPROPRIATE BY THE SUPERINTENDENT.
- 8. ALL DISTURBED AREAS OF STOCKPILES MUST BE SUITABLY STABILISED

#### SURFACE WATER AND DRAINAGE CONTROL

- 1. ALL DRAINAGE CONTROL MEASURES MUST BE APPLIED AND MAINTAINED IN ACCORDANCE WITH APPROVED ESCP DRAWINGS
- 2. DURING THE CONSTRUCTION PHASE, ALL REASONABLE AND PRACTICABLE MEASURES MUST BE IMPLEMENTED TO:
  - A.DIVERT CLEAN SURFACE WATERS AWAY FROM THE SITE IN A MANNER THAT MINIMISES EROSION OR CONTAMINATION OF WATER.
- B.CONTROL FLOW VELOCITIES AND PREVENT SOIL EROSION ALONG DRAINAGE PATHS, INCLUDING ENTRY/EXIT POINTS; AND ENSURE ALL WATERS ARE DISCHARGED ONTO STABLE LAND, IN A NON-EROSIVE MANNER, AND AT A LEGAL POINT OF DISCHARGE.
- C.MANAGEMENT OF DRAINAGE IS TO AVOID CONCENTRATION OF FLOW.
- D.OPEN PROFILE TRAPEZOIDAL DRAINS INSTEAD OF "V" DRAINS ARE TO BE USED.
- 3. CONTROL WATER MOVEMENT THROUGH THE WORKS AREA; FLOW DIVERSION BANKS AND CATCH DRAINS ARE TO BE INSTALLED AS PER DRAWINGS.

#### **EROSION CONTROL AND SURFACE STABILISATION**

- 1. ALL EROSION CONTROL MEASURES MUST BE APPLIED AND MAINTAINED IN ACCORDANCE WITH APPROVED ESCP DRAWINGS
- 2. SYNTHETIC EROSION CONTROL TREATMENTS MUST NOT BE USED IF SUCH MATERIALS ARE LIKELY TO CAUSE ENVIRONMENTAL HARM.

#### DUST CONTROL

- ALL DUST CONTROL MEASURES MUST BE APPLIED AND MAINTAINED IN ACCORDANCE WITH APPROVED ESCP DRAWINGS.
- 2. CONTRACTOR MUST BE RESPONSIBLE FOR THE EFFECTIVE CONTROL OF ALL DUST AND WINDBORNE MATERIAL EMANATING FROM THE SITE THROUGHOUT THE PERIOD OF THE CONTRACT.
- 3. CONTRACTOR MUST IMPLEMENT ALL MEASURES NECESSARY TO MINIMISE WIND EROSION AND PREVENT MATERIAL FROM THE SITE BEING BLOWN OVER OR ONTO PROPERTY OUTSIDE OF THE SITE. MEASURES MUST INCLUDE BUT NOT BE LIMITED TO:
  - A.MINIMISING TRAFFIC MOVEMENTS ON DISTURBED SURFACES AND LIMITING VEHICLE SPEEDS TO 25KPH;
- B.MAINTAINING EXPOSED SURFACES IN A MOIST CONDITION THROUGH FREQUENT WATERING;
- C.PROGRAMMING WORKS TO MINIMISE THE LIFE OF SOIL STOCKPILES, OR TEMPORARILY STABILISING LONG TERM
- 4. DURING DRY PERIODS, UTILISE WATER TRUCK TO WATER DOWN WORKS SURFACES TO MINIMISE DUST GENERATION.

  DUST SUPPRESSION IS TO BE IMPLEMENTED BY SITE SUPERVISOR AS REQUIRED BY VISUAL INSPECTION.

#### **DEWATERING**

COVER

- 1. CONTRACTOR MUST MITIGATE SEDIMENT RELATED ENVIRONMENTAL HARM AND/OR IMPACT TO STORMWATER INFRASTRUCTURE RESULTING FROM DEWATERING ACTIVITIES.
- FLOW DIVERSION BARRIERS, OR OTHER APPROPRIATE SYSTEMS, MUST BE USED TO MINIMISE THE QUANTITY OF WATER ENTERING EXCAVATIONS.
- 3. DEWATERING CONTROL MAY INCLUDE GEOFABRIC FILTERS AND NON-WOVEN FILTERING FENCING.
- 4. SEDIMENT LADEN WATER MUST NOT BE DISCHARGED OFF-SITE WITHOUT FIRST BEING TREATED SATISFACTORILY TO REQUIREMENTS OF THE SUPERINTENDENT.

#### DISCHARGED WATER MUST MEET THE FOLLOWING REQUIREMENTS: MAX 75 NTU, pH 6.5 TO 8.0.

# REVEGETATION AND REHABILITATION 1. ALL DISTURBED AREAS AND EARTHWORKS MUST BE PROGRESSIVELY REHABILITATED WITH GRASS, OR OTHER

#### SEDIMENT CONTROL

- 1. ALL SEDIMENT CONTROL MEASURES MUST BE APPLIED AND MAINTAINED IN ACCORDANCE WITH APPROVED ESCP
- 2. ALL REASONABLE AND PRACTICABLE MEASURES MUST BE TAKEN TO PREVENT, OR AT LEAST MINIMISE, THE RELEASE OF SEDIMENT FROM THE SITE. SEDIMENT CONTROL DEVICES MUST BE INSTALLED TO TRAP SEDIMENT AS CLOSE TO THE SOURCE AS PRACTICABLE.
- 3. SEDIMENT CONTROL DEVICES MUST NOT PRESENT A SAFETY HAZARD FOR SITE WORKERS AND/OR THE PUBLIC.
- 4. SEDIMENT FENCES AND/OR MULCH FILTER BERMS ARE TO BE INSTALLED ALONG THE DOWN SLOPE SIDE OF THE EARTHWORK ACTIVITIES AS PER IECA STANDARD DRAWINGS SF-01, SF-02 AND MB-01. ENSURE RETURNS ARE PROVIDED WHERE APPLICABLE.
- 5. SEDIMENT CONTROLS ARE TO REMAIN IN PLACE UNTIL THE ACTIVITIES ARE FINISHED AND AREAS ARE STABILISED.
- 6. TRACKING OF SEDIMENTS ONTO ROADS EXTERNAL OF THE SITE IS NOT PERMITTED. ENTRY/EXIT TO SITE MUST BE RESTRICTED TO DEFINED POINTS, WITH SUPPLEMENTARY ENTRY/EXIT SEDIMENT CONTROLS INSTALLED.
- 7. SEDIMENT CONTROL DEVICES MUST BE DE-SILTED WHEN CAPACITY IS REDUCED BELOW 80%.
- 8. SEDIMENT CONTROLS MUST BE INSPECTED WEEKLY DURING CONSTRUCTION AND IMMEDIATELY AFTER EACH RAINFALL EVENT.

#### **MONITORING**

- EROSION AND SEDIMENT CONTROLS ARE DESIGNED IN ACCORDANCE WITH IECA BEST PRACTICE GUIDELINES, USING
  AN EROSION RISK ASSESSMENT TO CONFIRM THE TYPE OF CONTROLS REQUIRED AROUND EACH SUB-CATCHMENT OF
  THE SITE.
- 2. WHERE TYPE 2/3 CONTROLS ARE APPLIED IN THE FORM OF MULCH BERMS, EROSION RISKS IN THESE SUB-CATCHMENTS ARE CONSIDERED TOLERABLE AND RELEASE OF SOME TURBID WATER OFFSITE THROUGH THESE BERMS IS TO BE EXPECTED.
- 3. WHERE EROSION AND SEDIMENT CONTROLS FAIL, RESULTING IN DISCHARGE OF SEDIMENT OFFSITE, THE CONTRACTOR MUST NOTIFY THE RELEVANT REGULATORY AUTHORITIES TO THE EXTENT REQUIRED UNDER RELEVANT ENVIRONMENTAL LEGISLATION.

#### MAINTFNANC

- 1. ALL EROSION AND SEDIMENT CONTROL MEASURES, INCLUDING DRAINAGE CONTROL MEASURES, MUST BE MAINTAINED IN PROPER WORKING ORDER AT ALL TIMES DURING THEIR OPERATIONAL LIVES.
- 2. ALL EROSION AND SEDIMENT CONTROL MEASURES MUST BE INSPECTED:
  - A.AT LEAST DAILY (WHEN WORK IS OCCURRING ON-SITE);
  - B.AT LEAST WEEKLY (WHEN WORK IS NOT OCCURRING ON-SITE);
  - C. WITHIN 24 HOURS PRIOR TO EXPECTED RAINFALL; AND
  - D.WITHIN 18 HOURS FOLLOWING A RAINFALL EVENT OF SUFFICIENT INTENSITY AND DURATION TO CAUSE RUNOFF ON-SITE.
- 3. CONTRACTOR MUST REPAIR ANY DAMAGED EROSION AND SEDIMENT CONTROL MEASURES, AND MAKE GOOD TO THE SATISFACTION OF THE SUPERINTENDENT.
- 4. CONTRACTOR MUST ENSURE SEDIMENT CONTROL DEVICES ARE DE-SILTED AND MADE FULLY OPERATIONAL AS SOON AS PRACTICABLE AFTER SEDIMENT-PRODUCING EVENTS, TO ENSURE THE SEDIMENT RETENTION CAPACITY IS MAINTAINED ABOVE 80% OF ITS DESIGN RETENTION CAPACITY.
- 5. ALL MATERIALS, WHETHER LIQUID OR SOLID, REMOVED FROM SEDIMENT CONTROL DEVICES AND PLACES OF SEDIMENT DEPOSITION, MUST BE DISPOSED OF IN AN APPROVED MANNER THAT DOES NOT CAUSE FURTHER SOIL EROSION OR ENVIRONMENTAL HARM. MATERIALS MUST BE DISPOSED OF IN A LOCATION THAT PREVENTS MATERIALS RE-ENTERING THE SYSTEM.
- 6. ALL SEDIMENT DEPOSITED OFFSITE AS A DIRECT RESULT OF CONSTRUCTION ACTIVITIES MUST BE REMOVED AND THE AREA APPROPRIATELY CLEANED / REHABILITATED AS SOON AS PRACTICABLE.
- 7. EROSION AND SEDIMENT CONTROL MEASURES MUST BE MAINTAINED UNTIL AFTER THE STOCKPILE IS REMOVED FROM THE SITE.
- 8. ALL TEMPORARY CONTROL MEASURES MUST BE REMOVED AFTER ACHIEVING A SATISFACTORY "OFF-MAINTENANCE INSPECTION" BY SUPERINTENDENT'S REPRESENTATIVE.

# WARNING BEWARE OF UNDERGROUND SERVICES


The locations of underground services are approximate only and their exact position should be proven on site No guarantee is given that all existing services are shown



BAYVIEW SUBDIVISION
LOT C
EROSION & SEDIMENT CONTROL

SCALE AS SHOWN PROJECT No 22007 PRAWING No SK006


B

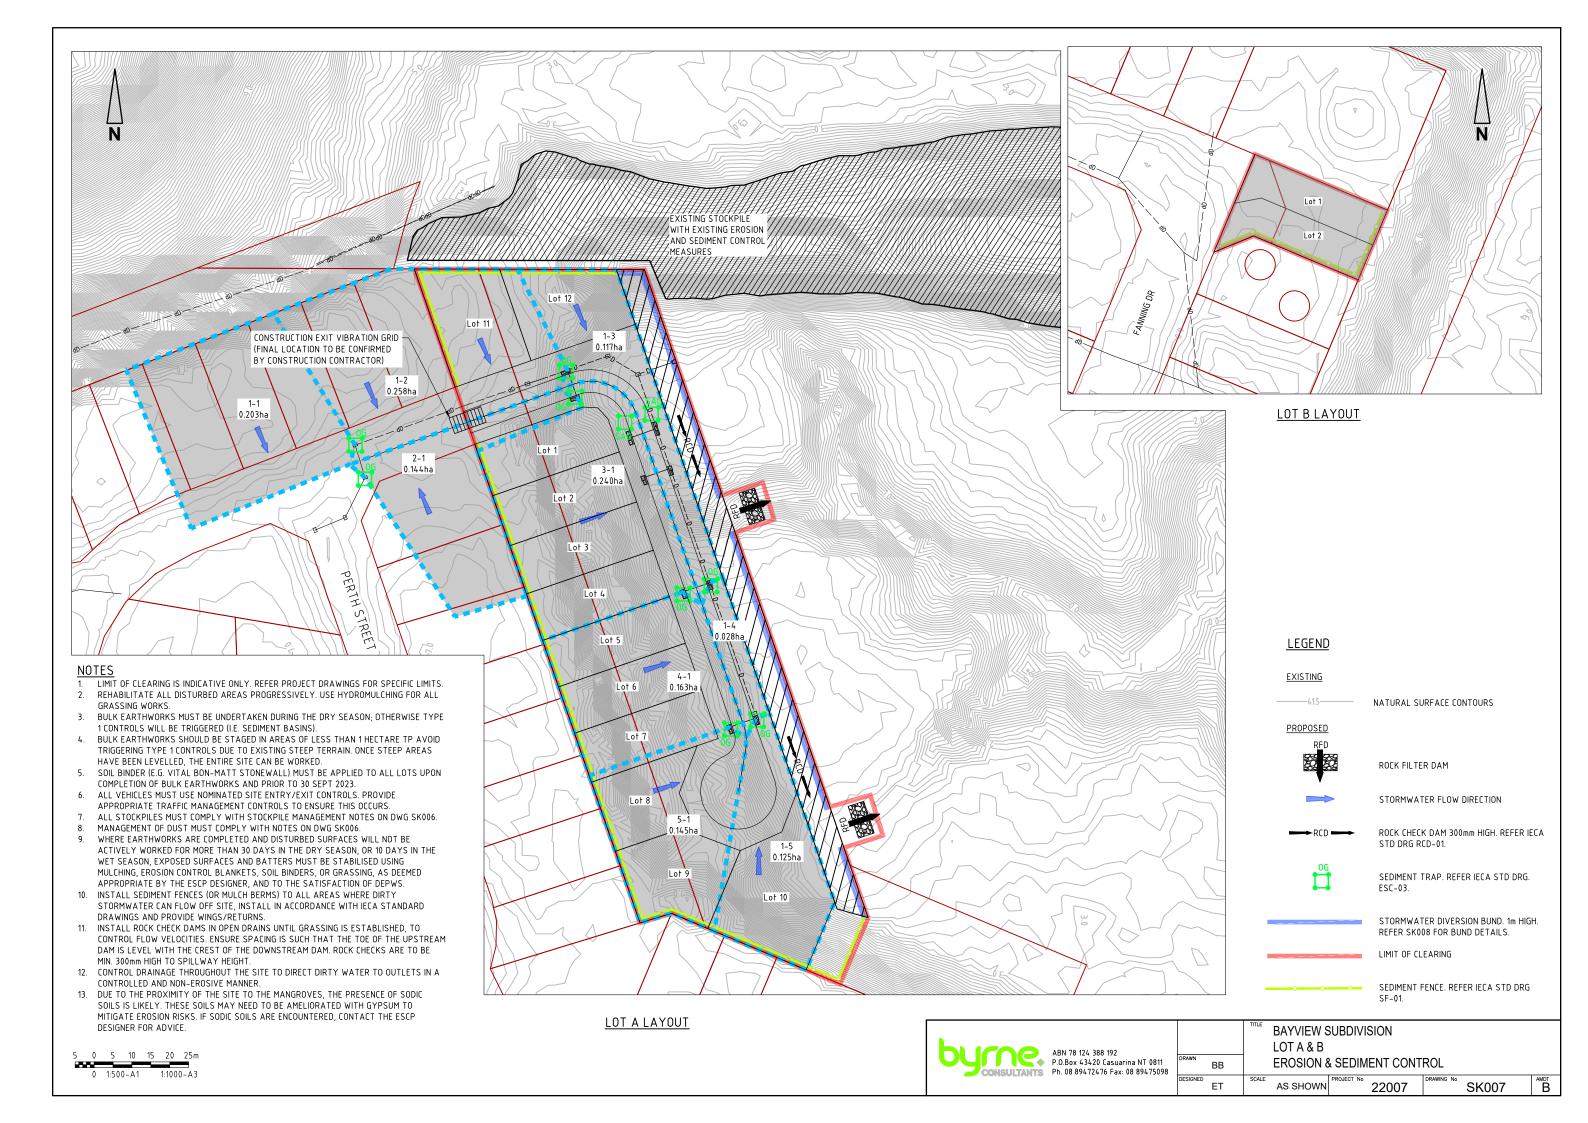


# Lot 1 1-1 0.122ha 2-1 0.040ha Lot 2 3-1 0.165ha Lot 3 Lot 4 4-1 0.179ha CONSTRUCTION EXIT VIBRATION GRID -(FINAL LOCATION TO BE CONFIRMED 0.126ha BY CONSTRUCTION CONTRACTOR) 8-1 0.220ha O'FERRALS ROAD 0.043ha LOT C LAYOUT

- LIMIT OF CLEARING IS INDICATIVE ONLY. REFER PROJECT DRAWINGS FOR SPECIFIC LIMITS.
- REHABILITATE ALL DISTURBED AREAS PROGRESSIVELY. USE HYDROMULCHING FOR ALL
- BULK EARTHWORKS MUST BE UNDERTAKEN DURING THE DRY SEASON; OTHERWISE TYPE 1 CONTROLS WILL BE TRIGGERED (I.E. SEDIMENT BASINS).
- BULK EARTHWORKS SHOULD BE STAGED IN AREAS OF LESS THAN 1 HECTARE TP AVOID TRIGGERING TYPE 1 CONTROLS DUE TO EXISTING STEEP TERRAIN. ONCE STEEP AREAS HAVE BEEN LEVELLED, THE ENTIRE SITE CAN BE WORKED.
- SOIL BINDER (E.G. VITAL BON-MATT STONEWALL) MUST BE APPLIED TO ALL LOTS UPON SOIL BINDER (E.G. VITAL BUN-MATT STONEWALL) MOST BE APPLIED TO ALL LOTS OPON COMPLETION OF BULK EARTHWORKS AND PRIOR TO 30 SEPT 2023.
  ALL VEHICLES MUST USE NOMINATED SITE ENTRY/EXIT CONTROLS. PROVIDE APPROPRIATE TRAFFIC MANAGEMENT CONTROLS TO ENSURE THIS OCCURS.
  ALL STOCKPILES MUST COMPLY WITH STOCKPILE MANAGEMENT NOTES ON DWG SK006.
  MANAGEMENT OF DUST MUST COMPLY WITH NOTES ON DWG SK006.
  WHERE EARTHWORKS ARE COMPLETED AND DISTURBED SURFACES WILL NOT BE

- ACTIVELY WORKED FOR MORE THAN 30 DAYS IN THE DRY SEASON, OR 10 DAYS IN THE WET SEASON, EXPOSED SURFACES AND BATTERS MUST BE STABILISED USING MULCHING, EROSION CONTROL BLANKETS, SOIL BINDERS, OR GRASSING, AS DEEMED APPROPRIATE BY THE ESCP DESIGNER, AND TO THE SATISFACTION OF DEPWS.
- 10. INSTALL SEDIMENT FENCES (OR MULCH BERMS) TO ALL AREAS WHERE DIRTY STORMWATER CAN FLOW OFF SITE, INSTALL IN ACCORDANCE WITH IECA STANDARD DRAWINGS AND PROVIDE WINGS/RETURNS.
- 11. INSTALL ROCK CHECK DAMS IN OPEN DRAINS UNTIL GRASSING IS ESTABLISHED, TO CONTROL FLOW VELOCITIES. ENSURE SPACING IS SUCH THAT THE TOE OF THE UPSTREAM DAM IS LEVEL WITH THE CREST OF THE DOWNSTREAM DAM. ROCK CHECKS ARE TO BE MIN. 300mm HIGH TO SPILLWAY HEIGHT.
- 12. CONTROL DRAINAGE THROUGHOUT THE SITE TO DIRECT DIRTY WATER TO OUTLETS IN A CONTROLLED AND NON-EROSIVE MANNER.
- DUE TO THE PROXIMITY OF THE SITE TO THE MANGROVES, THE PRESENCE OF SODIC SOILS IS LIKELY. THESE SOILS MAY NEED TO BE AMELIORATED WITH GYPSUM TO MITIGATE EROSION RISKS. IF SODIC SOILS ARE ENCOUNTERED, CONTACT THE ESCP DESIGNER FOR ADVICE.

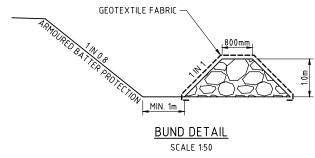

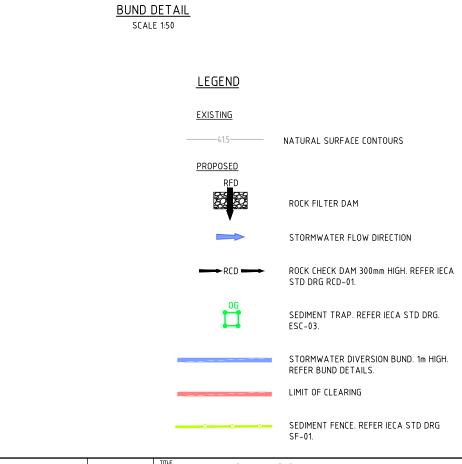





	TITLE	BAYVIEW S	SUBDIVI	SION		
AWN BB		EROSION 8	& SEDIM	IENT CONT	ROL	
SIGNED ET	SCALE	AS SHOWN	PROJECT No	22007	DRAWING No	SK008